CONWAY STREET PARK NORTH PLAZA REDESIGN

DESIGN DEVELOPMENT + PRICING SET NOVEMBER 15, 2023

SHEET LIST:

SITE ONE: ONSITE PARCEL

- C100 EXISTING SITE PLAN
- C101 DEMOLITION PLAN
- C200 PROPOSED SITE PLAN
- L101 KEY PLAN
- L102 MATERIALS PLAN
- L103 LAYOUT PLAN: PAVING
- L104 LAYOUT PLAN: SITE AMENITIES
- L201 HARDSCAPE DETAILS
- L301 PLANTING PLAN
- L401 PLANTING DETAILS
- L402 PLANTING NOTES

SHEET LIST:

SITE TWO: RIGHT-OF-WAY PARCEL

- C100R EXISTING SITE PLAN
- C101R DEMOLITION PLAN
- C200R PROPOSED SITE PLAN
- L101 KEY PLAN
- L102 MATERIALS PLAN
- L103 LAYOUT PLAN: PAVING
- L104 LAYOUT PLAN: SITE AMENITIES
- L201 HARDSCAPE DETAILS
- L301 PLANTING PLAN
- L401 PLANTING DETAILS
- L402 PLANTING NOTES



SITE PLAN





















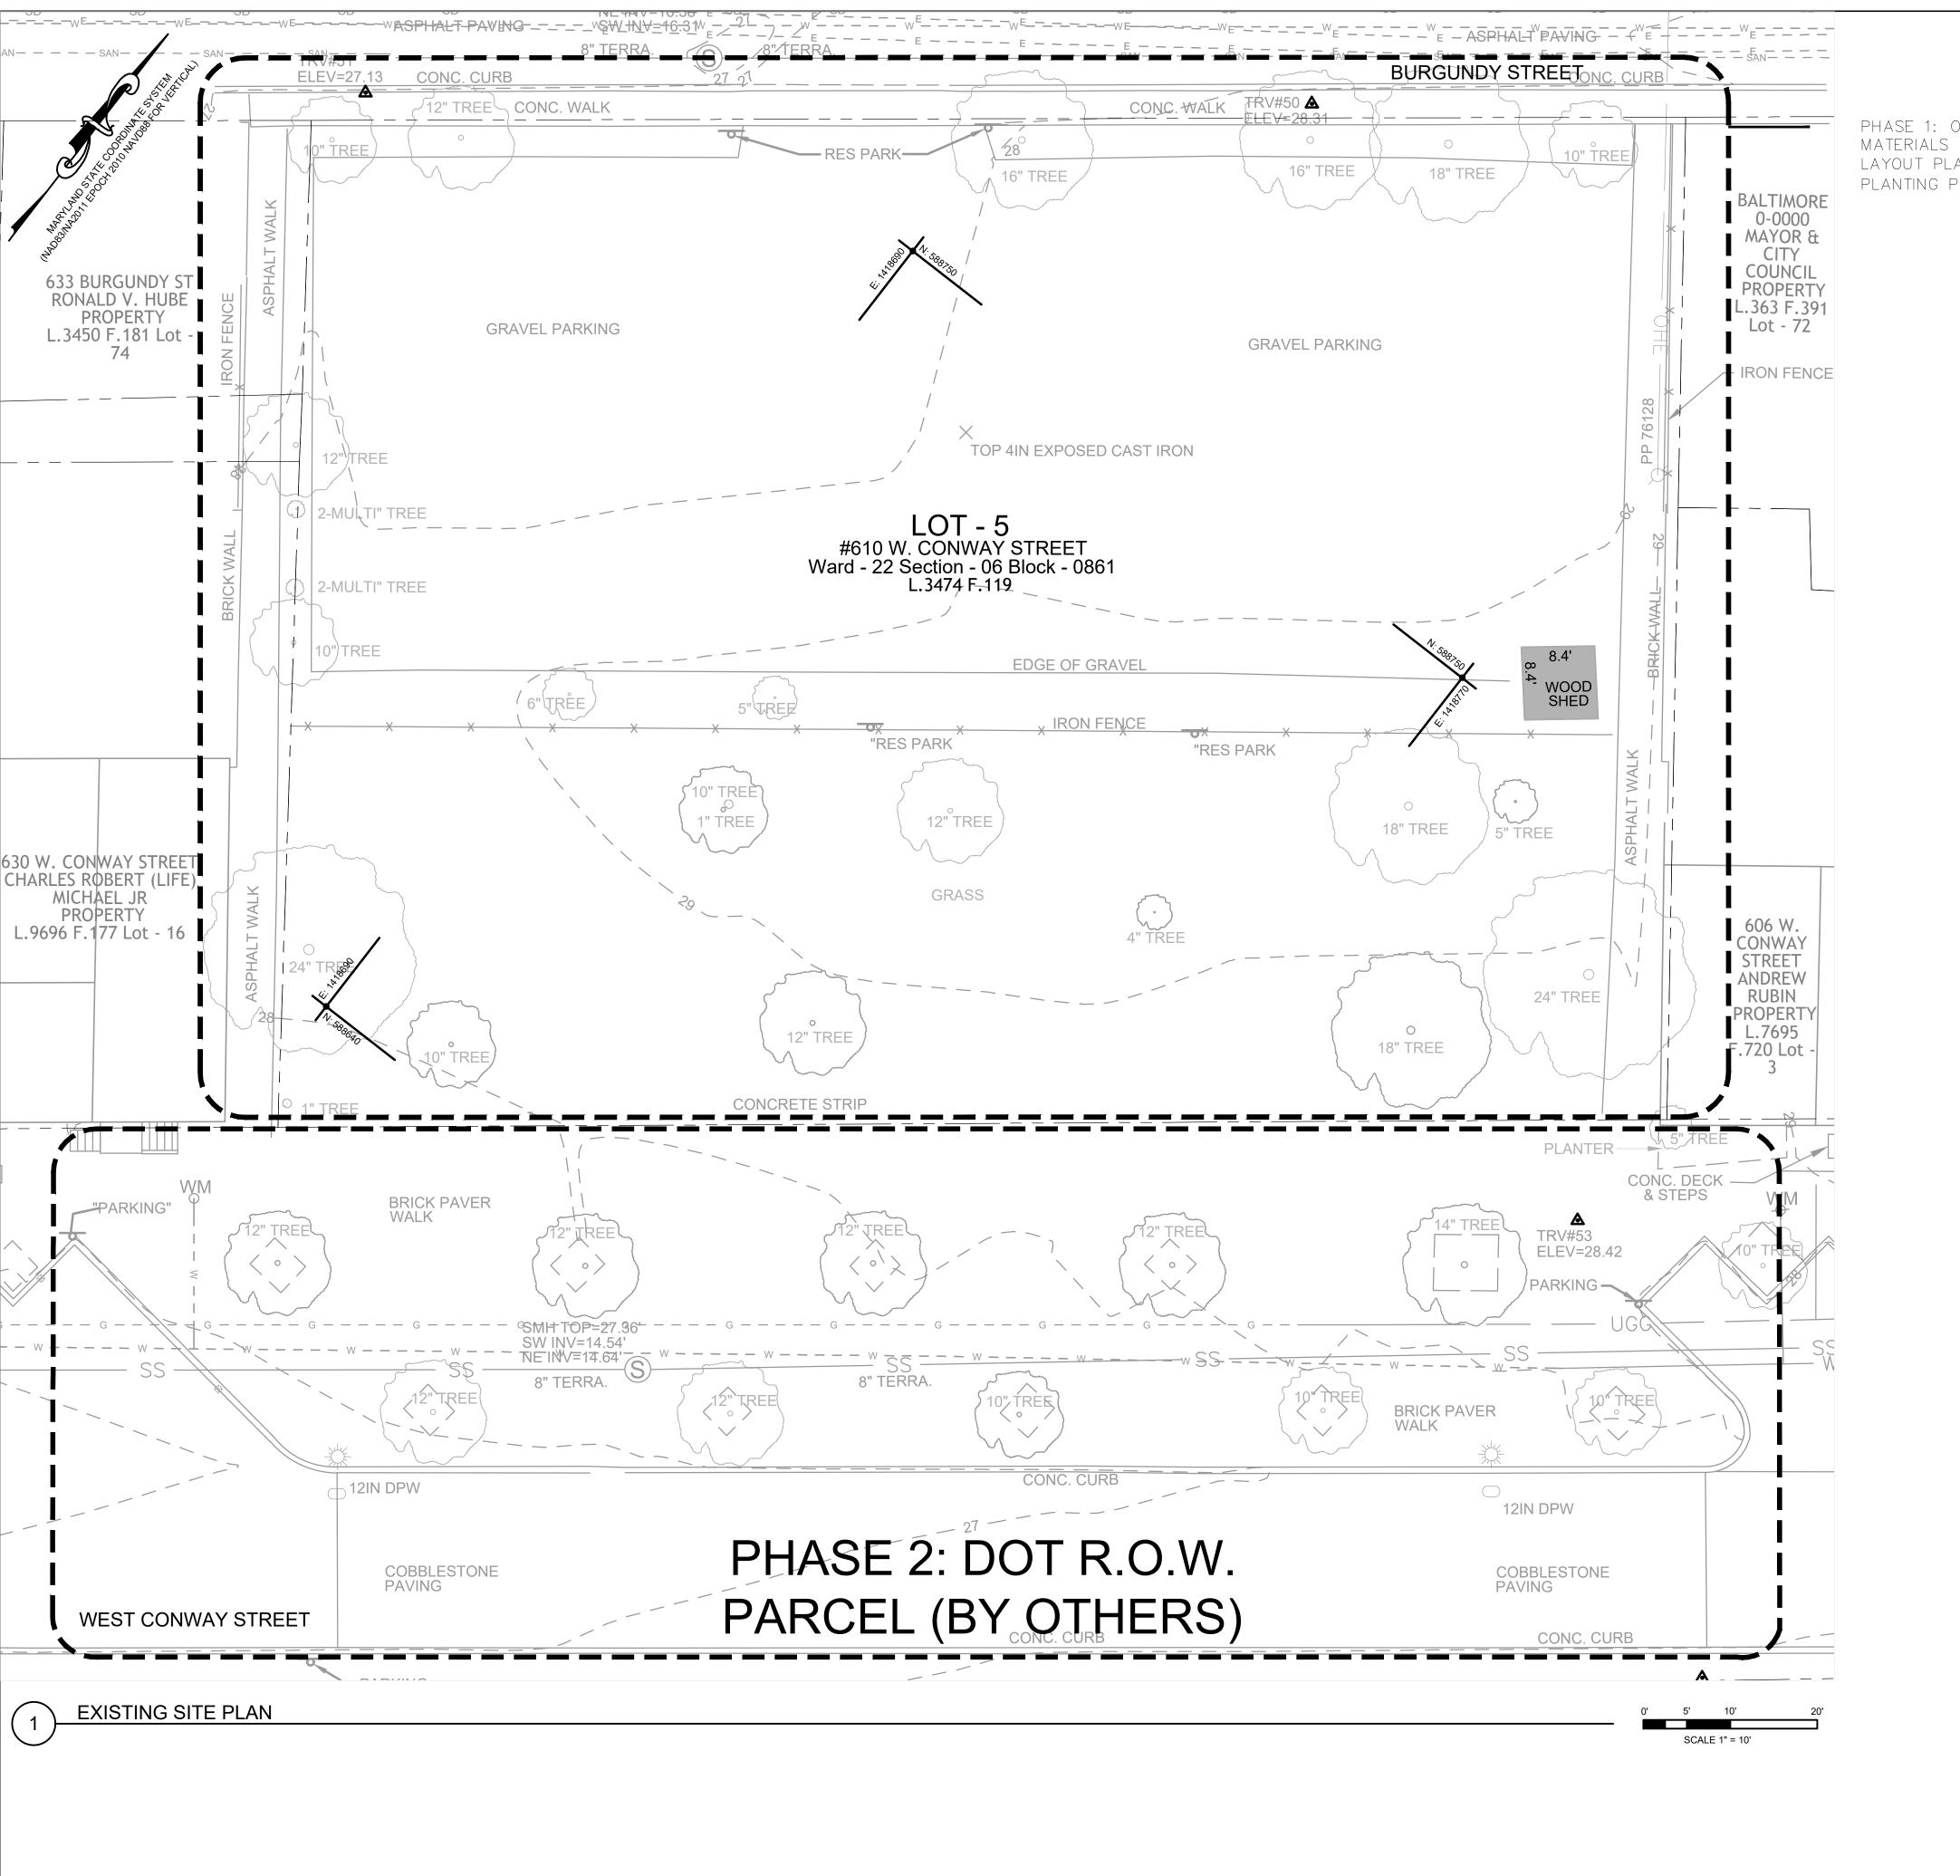

Paper Size: ANSI full bleed D (34.00 x 22.00 Inches)

PHASE 1: ON SITE MATERIALS PLAN SEE 1/L102 LAYOUT PLANS SEE 1/L103A, L103B PLANTING PLAN SEE 1/301

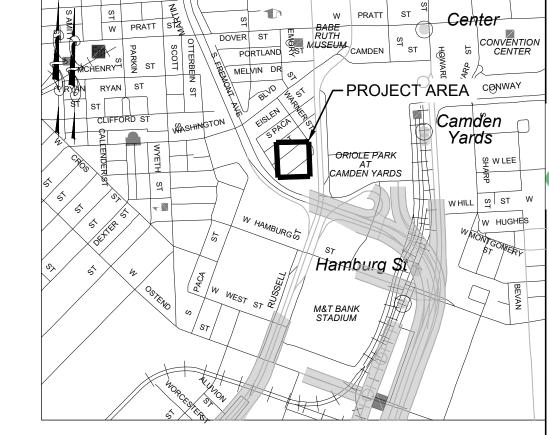

VICINITY MAP SOURCE: SHA GRID MAP D-12B SCALE 1"=1000'

GENERAL SURVEY NOTES:

1. THE LOCATION OF IMPROVEMENTS SHOWN HEREON ARE DERIVED FROM MARYLAND COORDINATE SYSTEM (NAD83/NA2011 EPOCH 2010) & NAVD88 FOR VERTICAL:

> Northing(Y) Easting(X) Elev(Z) Description 588424.57 1418839.08 31.99 MAG NAIL

SITE DATA:

OWNERSHIP: MAYOR AND CITY COUNCIL

DEED: L.3437 F.119

ADDRESS: 610 W. CONWAY STREET, BALTIMORE, MD 21201


LOT 5 - WARD 22 - SECTION 6 - BLOCK 861

- 3. A BOUNDARY SURVEY WAS NOT PERFORMED. PROPERTY LINES AND BUILDING LOCATION SHOWN HEREON ARE BASED ON GIS DATA AVAILABLE FROM BALTIMORE CITY.
- 4. UTILITY INFORMATION SHOWN HEREON IS BASED ON ABOVE-GROUND LOCATIONS AND PAINT
- 5. ADDITIONAL INFORMATION SHOWN HEREON IS BASED ON INFORMATION PREPARED BY ENVIROCOLLAB, LLC & CITYSCAPE ENGINEERING, LLC.

UTILITY NOTES:

- 1. SUBSURFACE UTILITY LOCATIONS SHOWN ON THIS PLAN WERE ESTIMATED BASED ON OBSERVED SURFACE MARKERS, RESULTS OF THE MISS UTILITY DESIGN TICKET, AND UTILITY PLANS PROVIDED BY UTILITY COMPANIES. THE CORRECTNESS AND COMPLETENESS OF THE UTILITY INFORMATION IS NOT WARRANTED OR GUARANTEED. THE CONTRACTOR SHALL VERIFY THE LOCATION OF ALL UTILITIES PRIOR TO CONSTRUCTION.
- 2. THE CONTRACTOR SHALL CONTACT MISS UTILITY AT 1-800-257-7777 AT LEAST THREE WORKING DAYS PRIOR TO STARTING WORK SO THEY CAN ARRANGE TO MARK THE HORIZONTAL LOCATION OF THEIR UNDERGROUND UTILITIES. ANY PERMITS OR COST ASSOCIATED WITH MISS UTILITY ARE THE RESPONSIBILITY OF THE CONTRACTOR.
- 3. ALL WORK SHALL BE SUBJECT TO INSPECTION BY UTILITY DEPARTMENT OFFICIALS.
- 4. CONTRACTOR SHALL CONDUCT TEST PITS TO VERIFY LOCATION AND ELEVATION OF ALL UNDERGROUND UTILITIES SHOWN ON THE PLANS IN AREAS OF CONSTRUCTION PRIOR TO STARTING WORK. CONTACT ENGINEER IMMEDIATELY, IF LOCATION OR ELEVATION IS DIFFERENT FROM THAT SHOWN ON THE PLAN, IF THERE APPEARS TO BE A CONFLICT, OR UPON DISCOVERY OF ANY UTILITY NOT SHOWN ON THE PLANS.
- 5. CONTRACTOR SHALL TAKE ALL NECESSARY PRECAUTIONS TO PROTECT AND MAINTAIN UNINTERRUPTED UTILITY SERVICE. ANY DAMAGE TO EXISTING STRUCTURES SHALL BE REPAIRED IMMEDIATELY TO THE SATISFACTION OF THE CITY UTILITY INSPECTOR, AT THE CONTRACTOR'S EXPENSE.THE CONTRACTOR SHALL IMMEDIATELY NOTIFY THE DEVELOPER AND THE UTILITY OWNER OF ANY DAMAGE TO THE UTILITY.

LEGEND

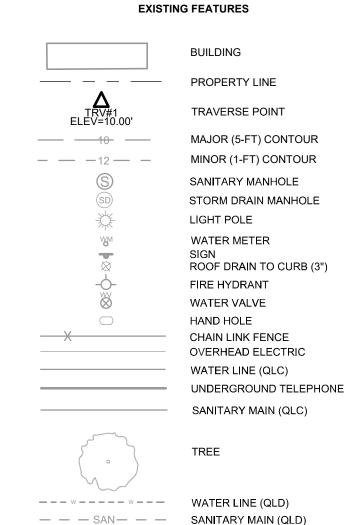

UNDERGROUND ELECTRIC (QLD)

LANDSCAPE ARCHITECT

ENVIROCOLLAB, LLC 111 E 25TH STREET, SUITE 1A BALTIMORE, MD 21218



LANDSCAPE ARCHITECTURE

CITYSCAPE ENGINEERING, LLC 3000 CHESTNUT AVE SUITE #112 BALTIMORE, MD 21211 PHONE: 410-601-3290

ENGINEER:

DEVELOPER/APPLICANT:

SOUTH BALTIMORE GATEWAY PARTNERSHIP 101 W. DICKMAN STREET STE 1000 BALTIMORE, MD 21230 PHONE: 410-424-7593

PROPERTY OWNER:

MAYOR AND CITY COUNCIL 100 N HOLLIDAY STREET BALTIMORE, MD 21202

NO.	REVISION	BY	DATE
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DRAWN: CJ CHECKED: XXX

DESIGNED: KL

LICENSE NO.: EXP. DATE:

PROFESSIONAL CERTIFICATION. I HEREBY CERTIFY THAT THESE DOCUMENTS WERE REPARED OR APPROVED BY ME, AND THAT I AM A DULY LICENSED PROFESSIONAL ENGINEER UNDER THE LAWS OF THE STATE OF MARYLAND,


PROJECT INFORMATION

610 W CONWAY STREET BALTIMORE, MD 21230 WARD 22, SECTION 060 BLOCK 0861, LOT 005 COUNCIL DISTRICT #11

ePLAN NO.: OCTOBER 2023 PROJECT NO.: SHEET TITLE: **EXISTING SITE PLAN**


DWG. NO.:

C-100

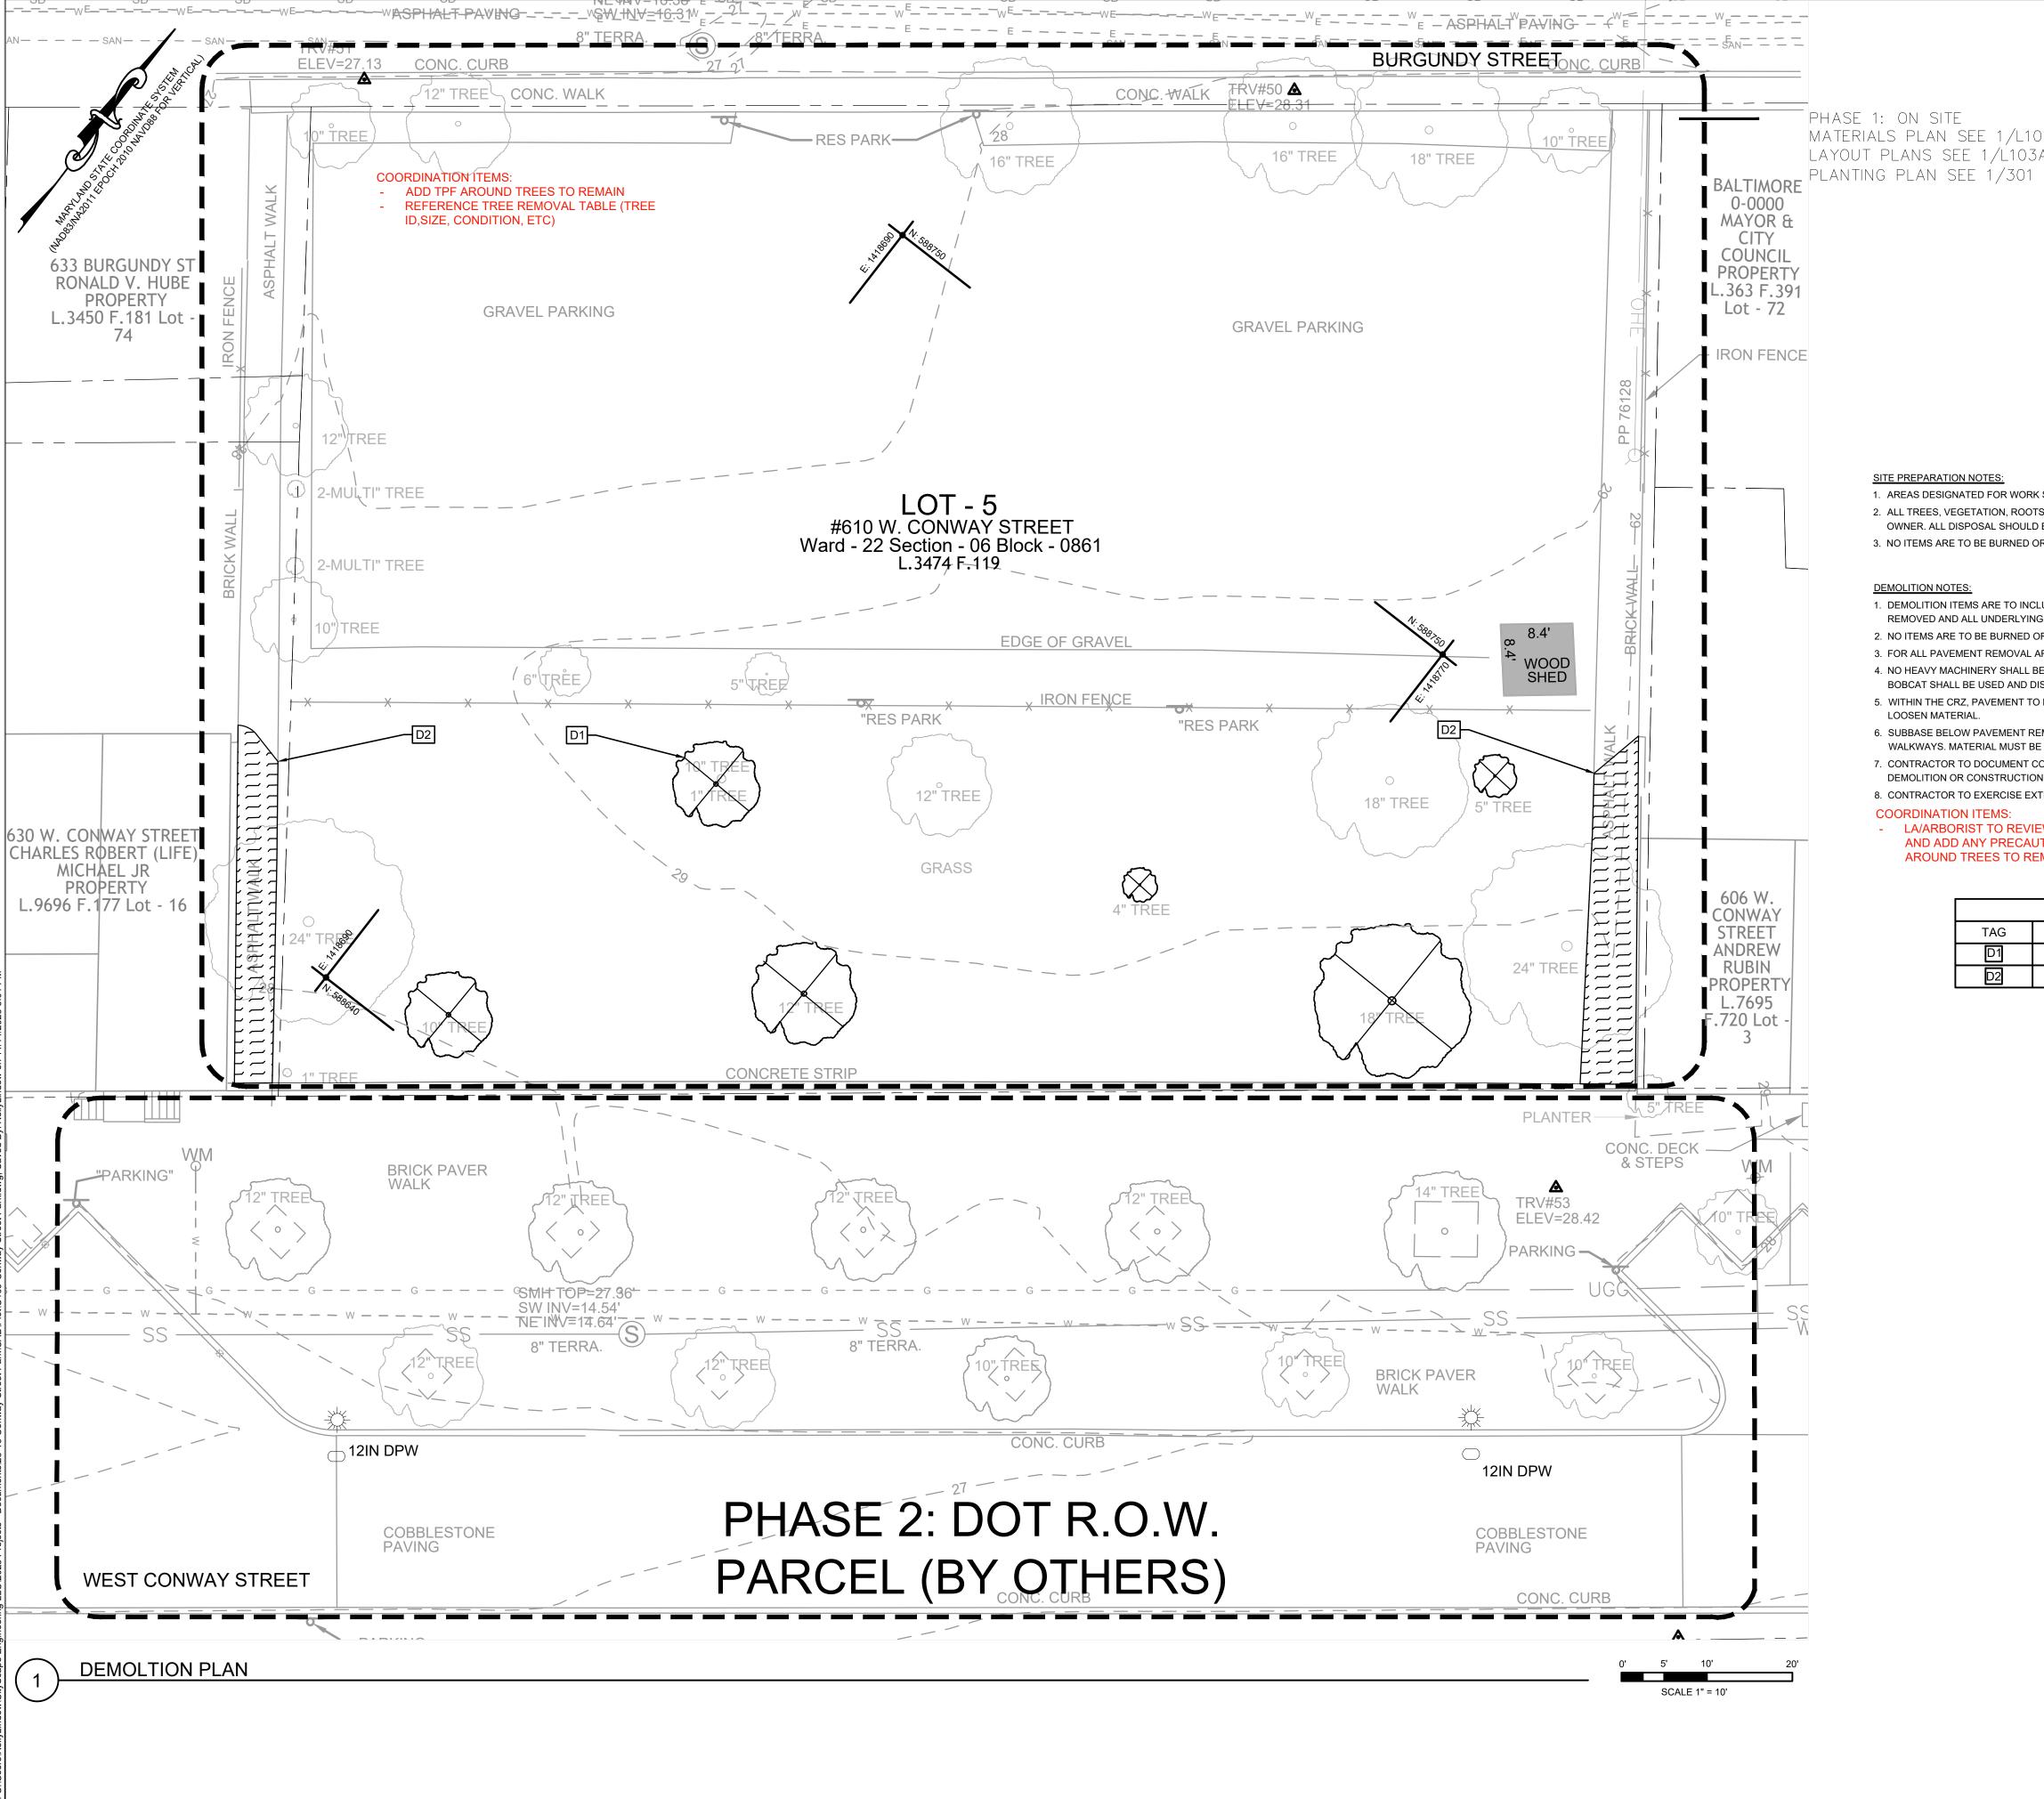

Paper Size: ANSI full bleed D (34.00 x 22.00 Inches)

PHASE 1: ON SITE MATERIALS PLAN SEE 1/L102 LAYOUT PLANS SEE 1/L103A, L103B

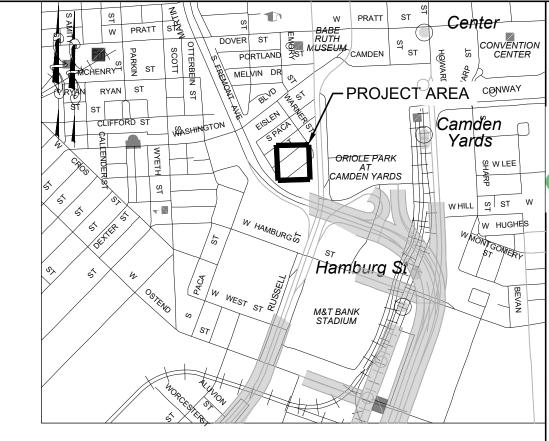

VICINITY MAP SOURCE: SHA GRID MAP D-12B SCALE 1"=1000'

SITE PREPARATION NOTES:

- 1. AREAS DESIGNATED FOR WORK SHALL BE CLEARED AND GRUBBED, AS NEEDED.
- 2. ALL TREES, VEGETATION, ROOTS, AND OTHER OBJECTIONABLE MATERIAL SHALL BE REMOVED AND DISPOSED OF OFF-SITE AS DIRECTED BY THE OWNER. ALL DISPOSAL SHOULD BE DONE AT A SITE WITH APPROVED APPLICABLE PERMITS.
- 3. NO ITEMS ARE TO BE BURNED OR BURIED ON THE SITE.


- 1. DEMOLITION ITEMS ARE TO INCLUDE ALL WORK REQUIRED TO REMOVE ITEM FROM SITE COMPLETELY. EXISTING IMPERVIOUS COVER TO BE
- REMOVED AND ALL UNDERLYING GRAVEL AND STONE ARE TO BE REMOVED AND HAULED FROM THE SITE.
- 2. NO ITEMS ARE TO BE BURNED OR BURIED ON THE SITE.
- 3. FOR ALL PAVEMENT REMOVAL AREAS, NEATLY SAWCUT ALL EDGES.
- 4. NO HEAVY MACHINERY SHALL BE ALLOWED WITHIN THE TREE CRITICAL ROOT ZONE (CRZ). FOR GRADING NEEDS WITHIN THE CRZ, ONLY A LIGHT
- BOBCAT SHALL BE USED AND DISTURBANCE SHOULD BE MINIMIZED. 5. WITHIN THE CRZ, PAVEMENT TO BE REMOVED MUST BE BROKEN UP BY A JACK HAMMER AND REMOVED BY HAND. AN AIR SPADE MAY BE USED TO
- 6. SUBBASE BELOW PAVEMENT REMOVAL AREAS MAY BE TEMPORARILY STOCKPILED ON SITE AND REUSED FOR CONSTRUCTION OF NEW
- WALKWAYS. MATERIAL MUST BE TESTED PRIOR TO REUSE AND SHALL MEET PROPOSED SUBBASE SPECIFICATIONS. 7. CONTRACTOR TO DOCUMENT CONDITION OF ALL ADJACENT PROPERTIES, BUILDINGS, STRUCTURES, RIGHT-OF-WAYS, AND UTILITIES PRIOR TO
- DEMOLITION OR CONSTRUCTION. 8. CONTRACTOR TO EXERCISE EXTREME CAUTION WHEN WORKING AROUND BGE ELECTRIC AND GAS INFRASTRUCTURE.

COORDINATION ITEMS:

- LA/ARBORIST TO REVIEW DEMOLTION NOTES AND ADD ANY PRECAUTIONS FOR WORK AROUND TREES TO REMAIN

	DEMOLITION KEYNOTES TABLE	
TAG	DESCRIPTION	QUANTITY
D1	TREE TO BE REMOVED	6
D2	ASPHALT TO BE REMOVED	407 SF

LEGEND

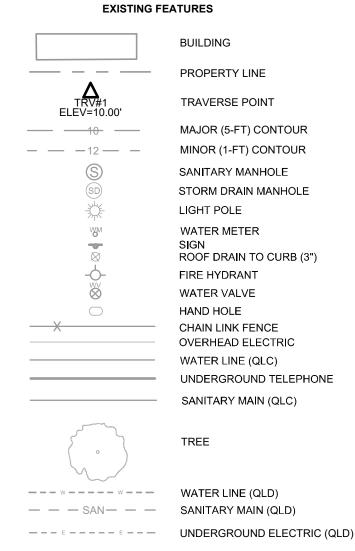

DEMO FEATURES



ASPHALT TO BE REMOVED

DEMOLITION PLAN

SHEET TITLE:

LANDSCAPE ARCHITECT

ENVIROCOLLAB, LLC 111 E 25TH STREET, SUITE 1A

BALTIMORE, MD 21218 PHONE: 443-956-9278

LANDSCAPE ARCHITECTURE

ENGINEER:

CITYSCAPE ENGINEERING, LLC 3000 CHESTNUT AVE

SUITE #112

BALTIMORE, MD 21211

PHONE: 410-601-3290

DEVELOPER/APPLICANT: SOUTH BALTIMORE GATEWAY

PARTNERSHIP 101 W. DICKMAN STREET

STE 1000

BALTIMORE, MD 21230 PHONE: 410-424-7593

PROPERTY OWNER:

MAYOR AND CITY COUNCIL

100 N HOLLIDAY STREET

BALTIMORE, MD 21202

REVISION

DRAWN: CJ CHECKED: XXX

PROFESSIONAL CERTIFICATION. I HEREBY

CERTIFY THAT THESE DOCUMENTS WERE

PROJECT INFORMATION

610 W CONWAY STREET BALTIMORE, MD 21230 WARD 22, SECTION 060

BLOCK 0861, LOT 005

COUNCIL DISTRICT #11

OCTOBER 2023

ePLAN NO.:

PROJECT NO.:

PREPARED OR APPROVED BY ME, AND THAT I AM A DULY LICENSED PROFESSIONAL ENGINEER UNDER THE LAWS OF THE STATE

DESIGNED: KL


OF MARYLAND, LICENSE NO.:

EXP. DATE:

BY DATE

DWG. NO.:

C-101

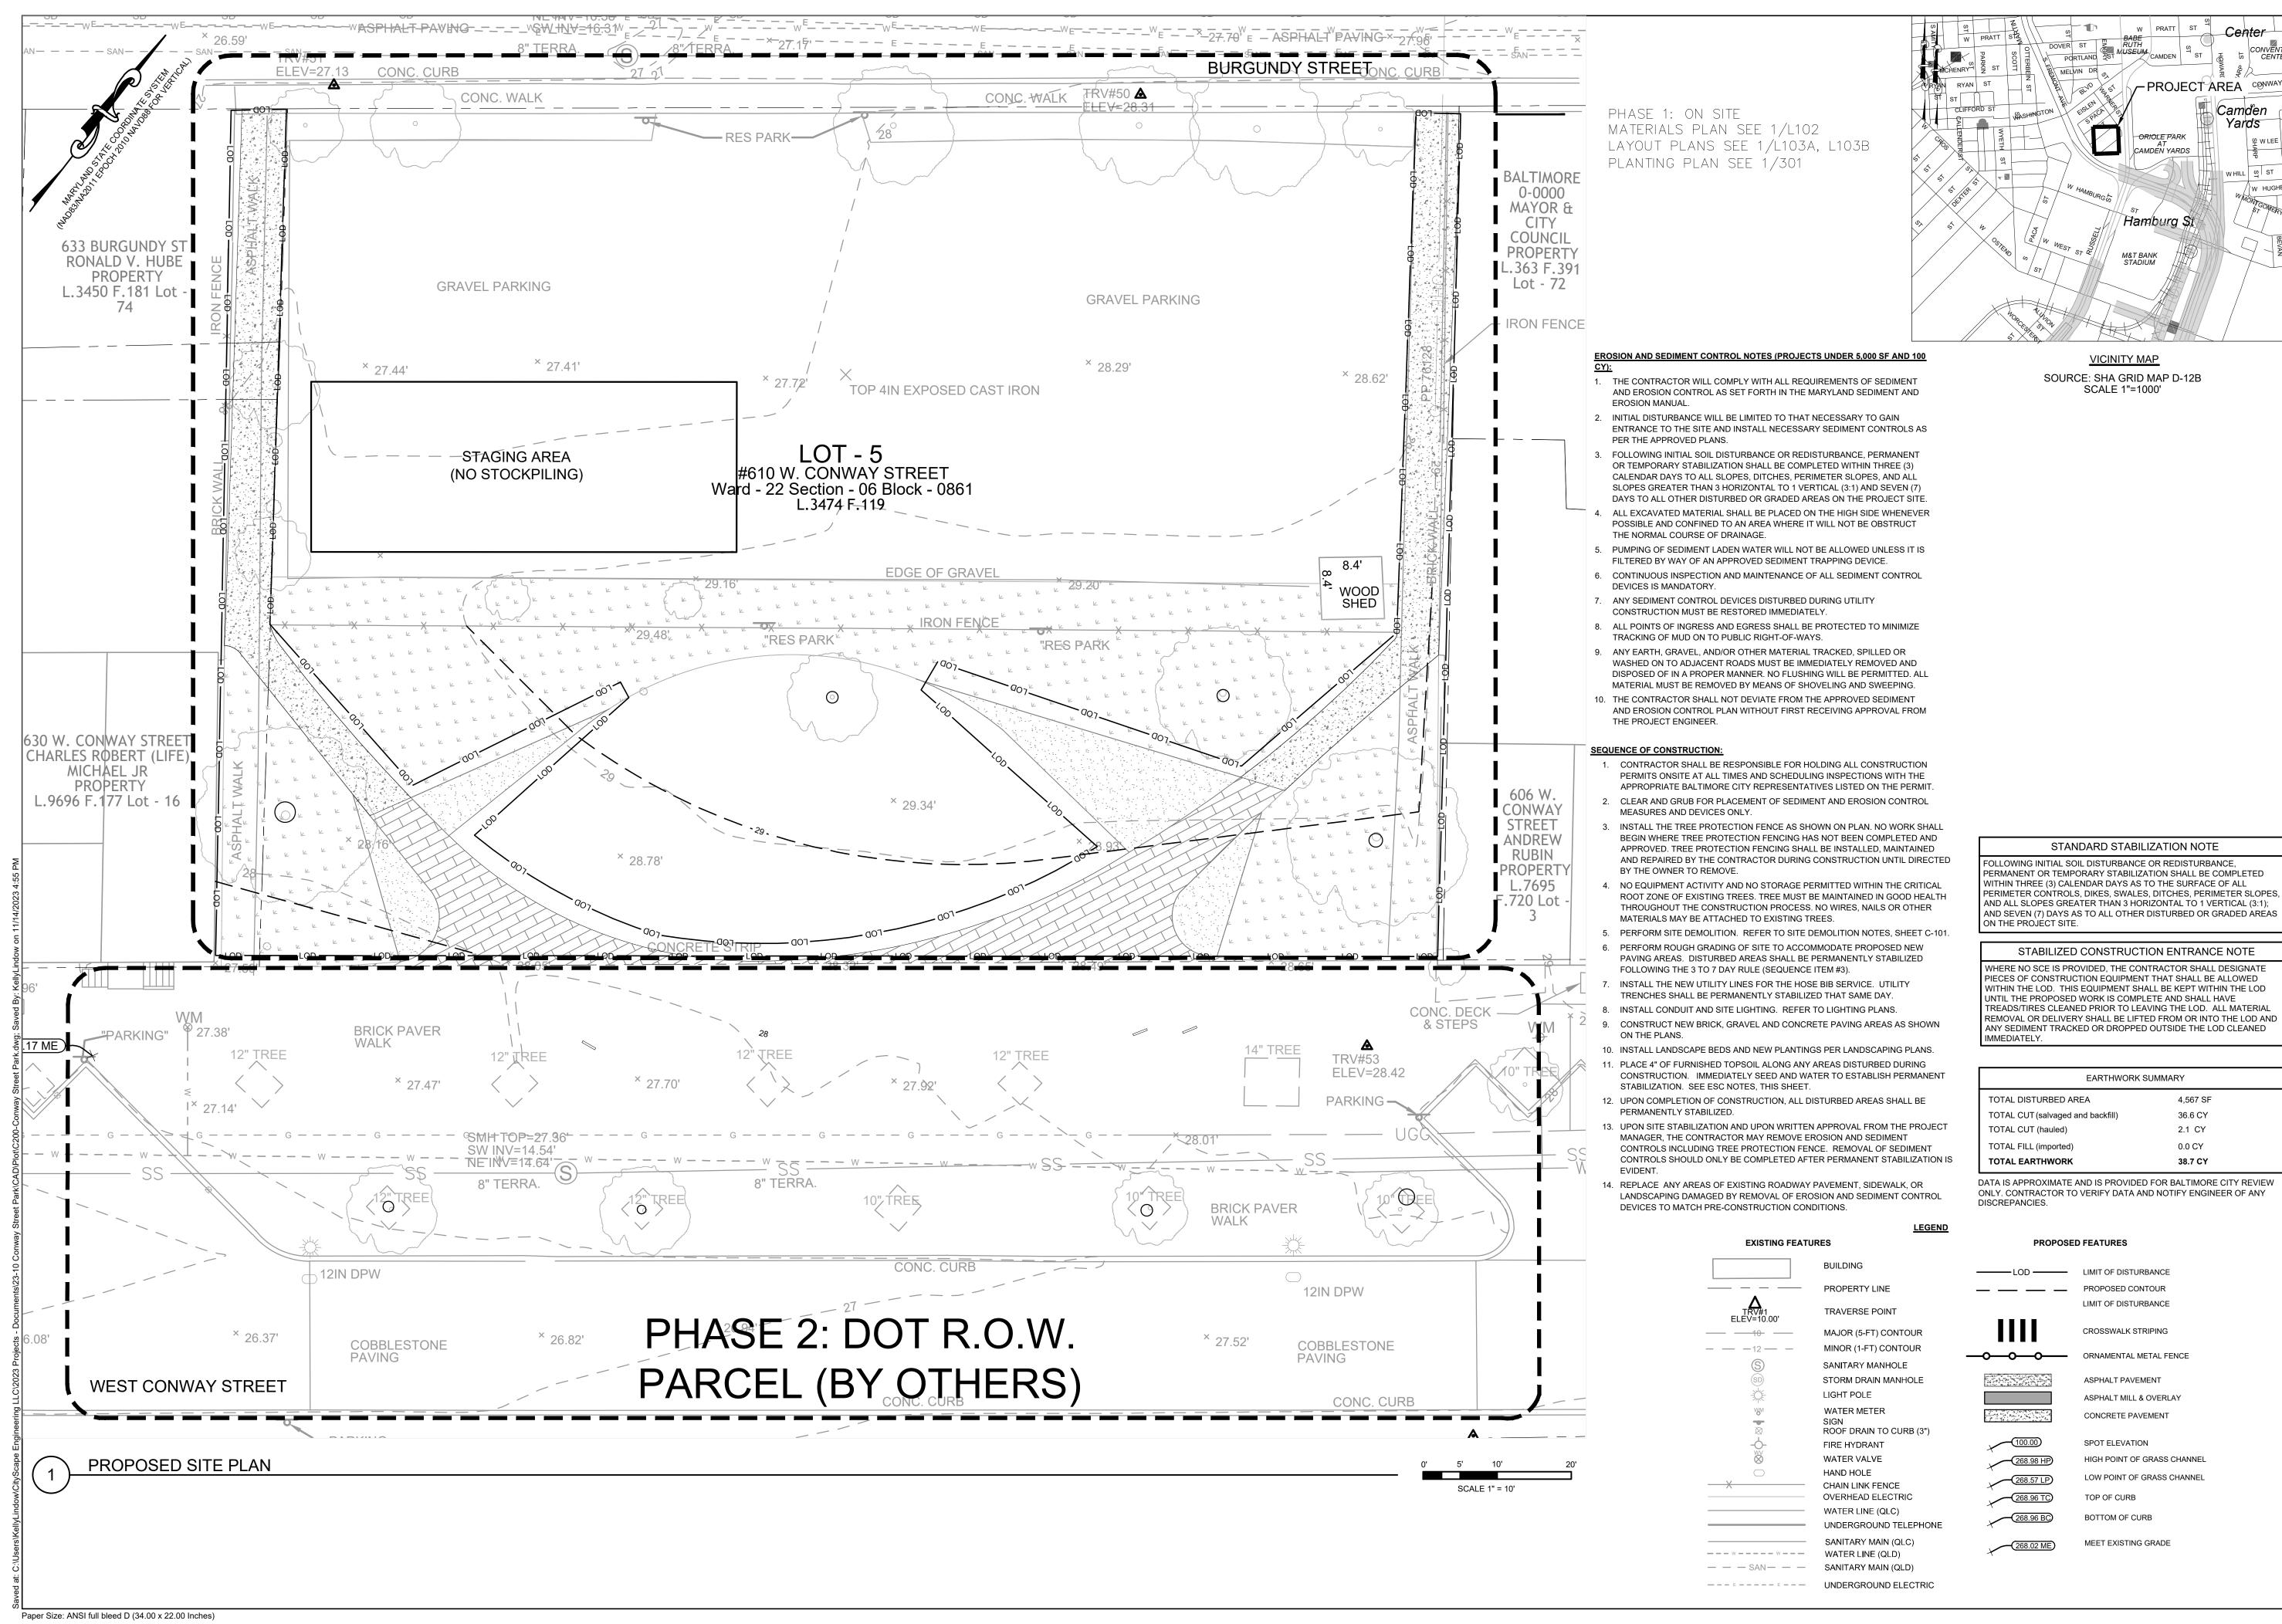

111 E 25TH STREET, SUITE 1A BALTIMORE, MD 21218



ENGINEER:

CITYSCAPE ENGINEERING, LLC 3000 CHESTNUT AVE SUITE #112 BALTIMORE, MD 21211 PHONE: 410-601-3290



DEVELOPER/APPLICANT

SOUTH BALTIMORE GATEWAY PARTNERSHIP 101 W. DICKMAN STREET STE 1000 BALTIMORE, MD 21230 PHONE: 410-424-7593

PROPERTY OWNER:

MAYOR AND CITY COUNCIL 100 N HOLLIDAY STREET BALTIMORE, MD 21202

BY DATE

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	DRAWN:		CJ	CHEC	KED:	xxx	

PROFESSIONAL CERTIFICATION. I HEREBY CERTIFY THAT THESE DOCUMENTS WERE

I AM A DULY LICENSED PROFESSIONAL

ENGINEER UNDER THE LAWS OF THE STAT

PROJECT INFORMATION

610 W CONWAY STREET BALTIMORE, MD 21230

WARD 22, SECTION 060

BLOCK 0861, LOT 005

COUNCIL DISTRICT #11

SHEET TITLE:

PROPOSED SITE PLAN

PROJECT NO.:

OCTOBER 2023

REPARED OR APPROVED BY ME, AND THAT

DESIGNED: KL

OF MARYLAND,

LICENSE NO.:

EXP. DATE:


REVISION

WHERE NO SCE IS PROVIDED. THE CONTRACTOR SHALL DESIGNATE PIECES OF CONSTRUCTION EQUIPMENT THAT SHALL BE ALLOWED WITHIN THE LOD. THIS EQUIPMENT SHALL BE KEPT WITHIN THE LOD JNTIL THE PROPOSED WORK IS COMPLETE AND SHALL HAVE

DATA IS APPROXIMATE AND IS PROVIDED FOR BALTIMORE CITY REVIEW ONLY. CONTRACTOR TO VERIFY DATA AND NOTIFY ENGINEER OF ANY

DWG. NO.:

C-200

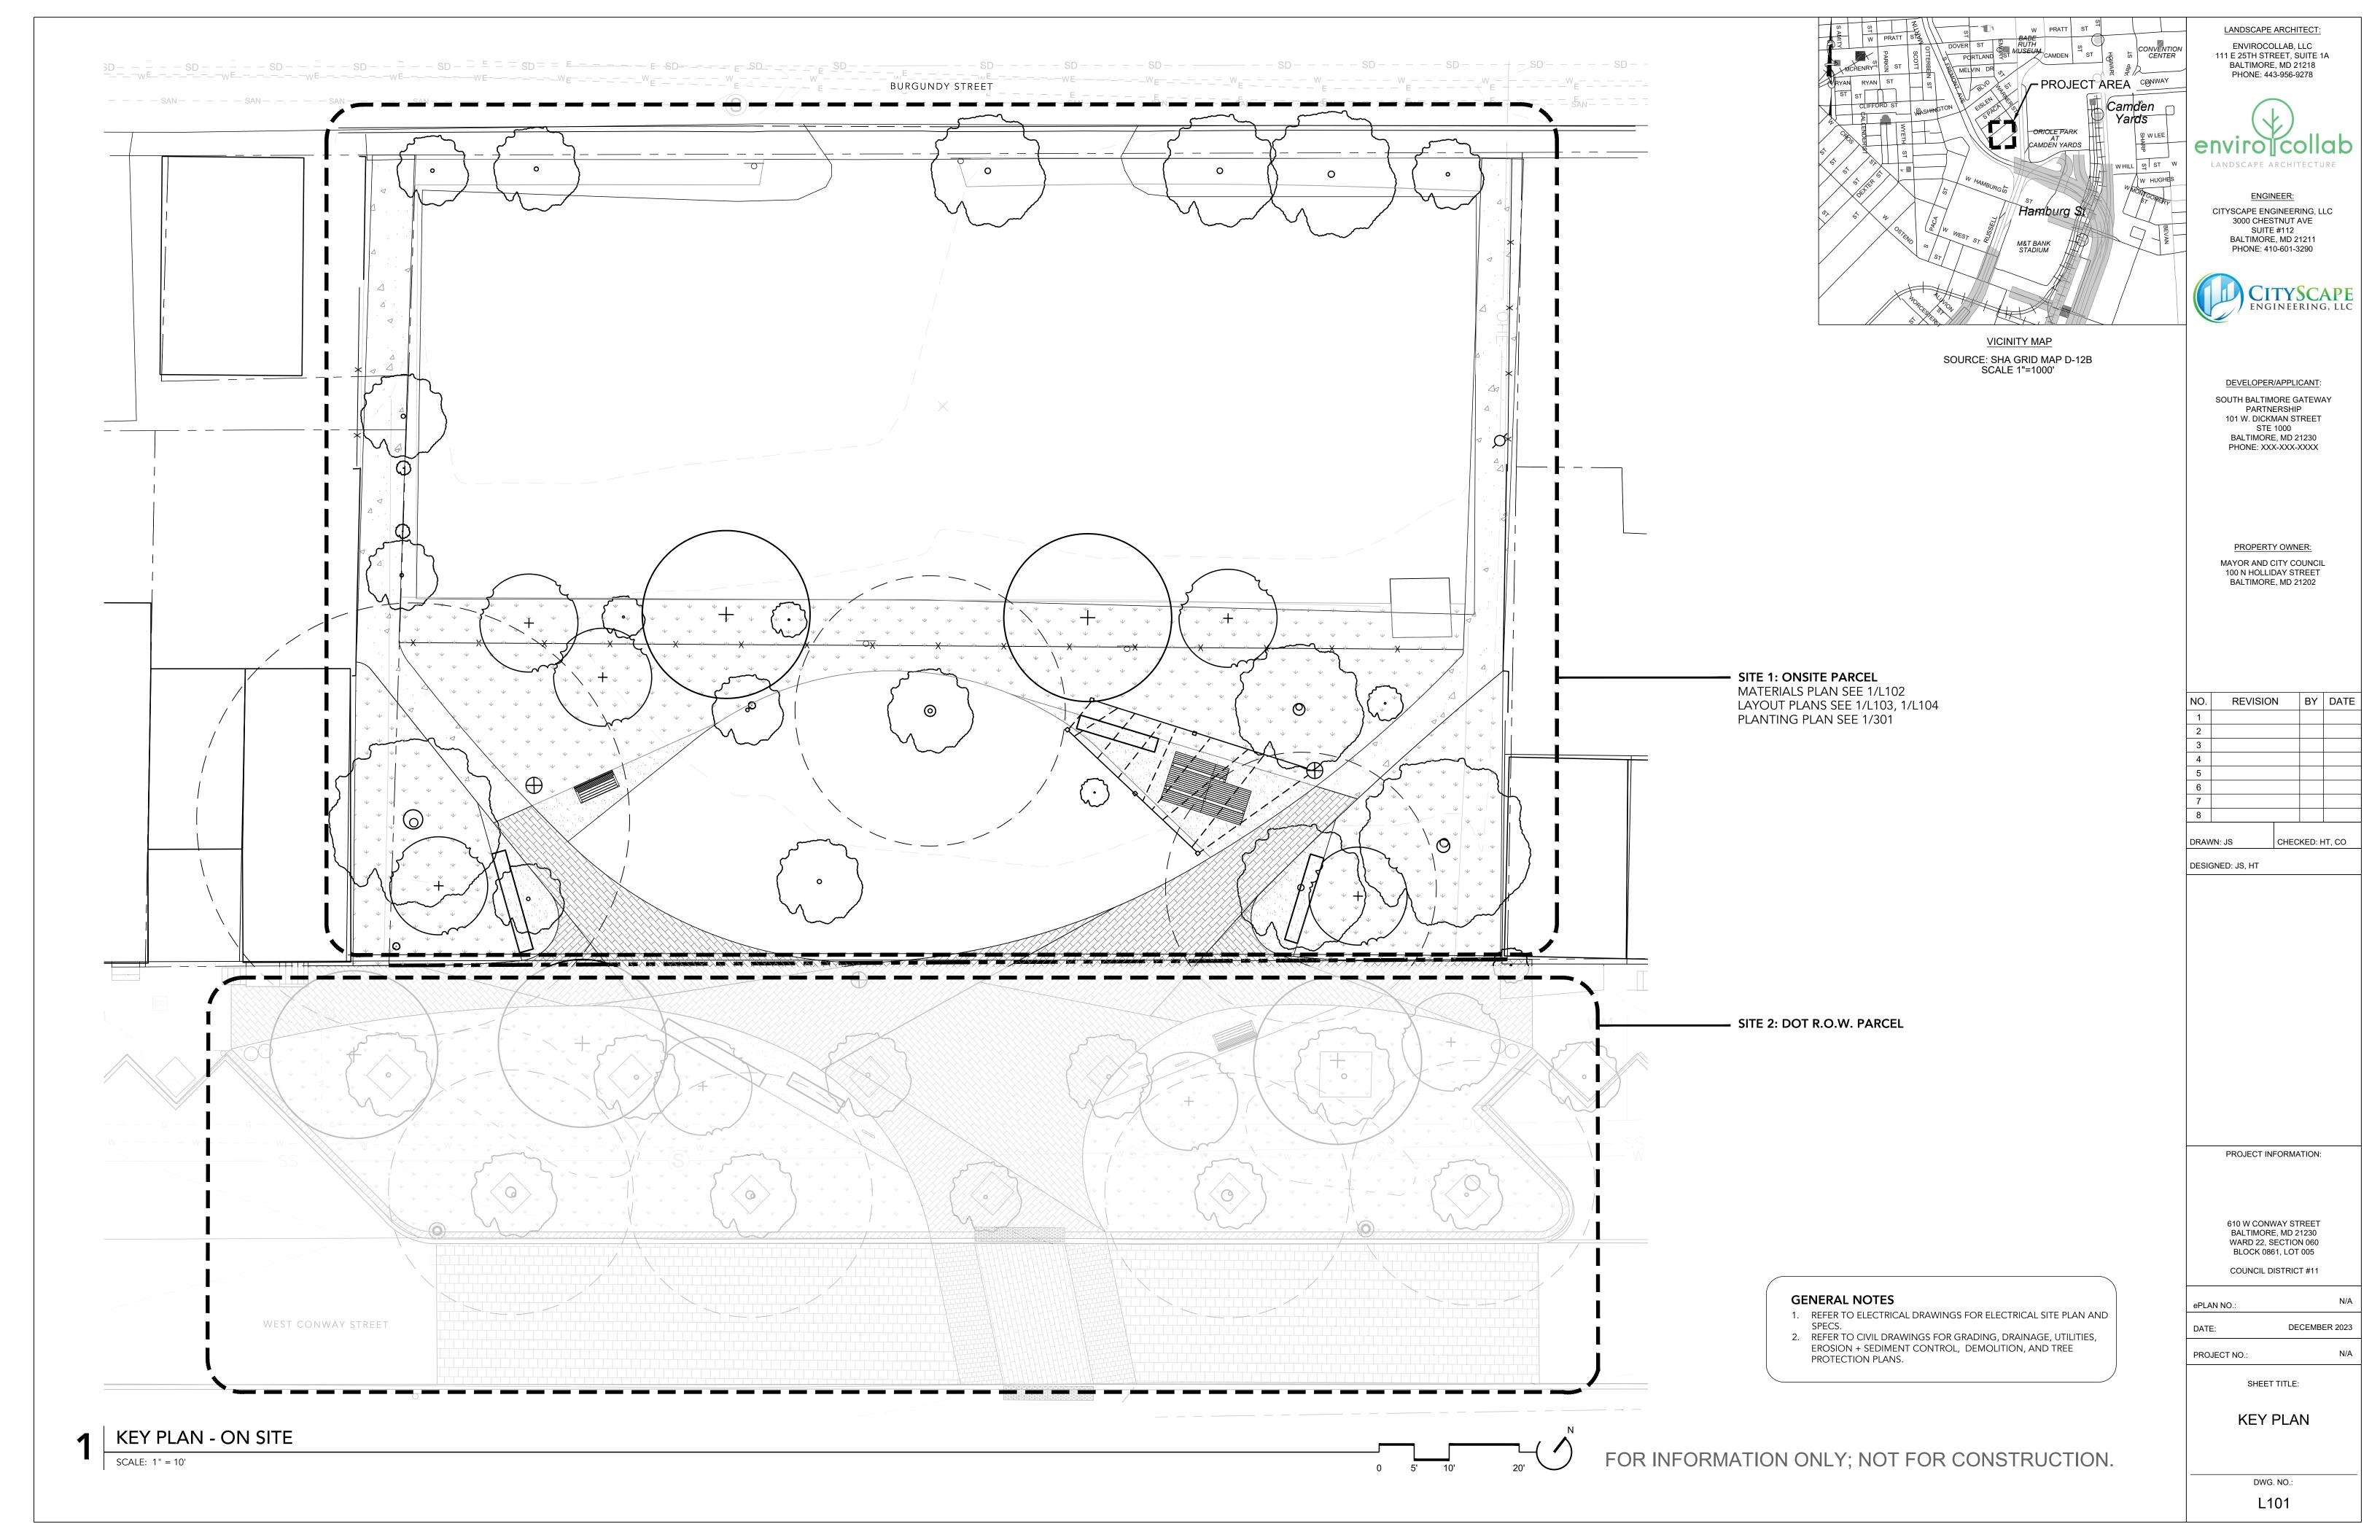

MEET EXISTING SIDEWALK AT BURGUNDY STREET EXISTING GRAVEL LOT TO REMAIN EXISTING SHED TO REMAIN —— EXISTING FENCE TO REMAIN — SEE R.O.W. DRAWINGS

MATERIALS PLAN

SCALE: 1" = 10'

HARDSCAPE & AMENITIES LEGEND


PAVING.




BRICK PAVING: CUSTOM PATTERN 4"x8"x 2 \frac{3}{4}" SALVAGED AND REUSED PAVER LAID IN CUSTOM PATTERN ON BITUMINOUS SETTING BED W/ CONCRETE BASE



(P1) ALI Z 4"THICK SCORED DECORATIVE CONCRETE PAVING ON COMPACTED GRADED AGGREGATE BASE

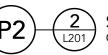


2 STONE DUST PAVING OVER COMPACTED AGGREGATE

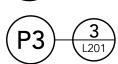

3 CONCRETE PAVING 4" THICK SCORED CONCRETE PAVING ON 4" COMPACTED, GRADED AGGREGATE SUBBASE

WALLS & CURBS.

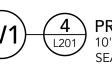

4 PRECAST CONCRETE SEAT WALL 10'L x 24"D x 18" H MOLDED CONCRETE SEATWALL ON CONCRETE SLAB

FURNISHINGS & FEATURES.



5 WOOD + METAL BENCH PREFABRICATED;XXXXXX APPROX. 6' L



PA

6 ADA WOOD + METAL COMMUNITY DINING TABLE W/ BENCHES PREFABRICATED; XXXXXX

LIGHTING.



12' HEIGHT DECORATIVE POLES

8 STRING LIGHTING
STRUNG BETWEEN WOODEN POLES

MATERIALS NOTES:

- 1. PA = PLANTING AREA; REFER TO L-301 FOR PLANTING PLAN. 2. REFER TO ELECTRICAL DRAWINGS FOR ELECTRICAL SITE PLAN
- 3. REFER TO CIVIL DRAWINGS FOR GRADING, DRAINAGE, UTILITIES, EROSION + SEDIMENT CONTROL, DEMOLITION, AND TREE PROTECTION PLANS.
- 4. CONTRACTOR TO SUBMIT SAMPLES AND PRODUCT INFORMATION FOR ALL PAVING, WALLS, AND FURNISHINGS FOR REVIEW BY LANDSCAPE ARCHITECT.
- 5. CONTRACTOR TO SUBMIT SHOP DRAWINGS FOR LAYOUT AND CONSTRUCTION OF ALL SITE WALLS, STAIRS, RAILINGS, FENCING AND GATES FOR REVIEW BY ARCHITECT AND LANDSCAPE
- 6. REFER TO L103 AND L104 FOR LAYOUT + GRADING INFORMATION, L200 SERIES FOR HARDSCAPE DETAILS, AND L300 SERIES FOR PLANTING PLANS.
- 7. THIS DRAWING PACKAGE INCLUDES INFORMATION TO CONVEY MATERIALS SELECTIONS AND DESIGN INTENT INFORMATION. CONTRACTOR IS RESPONSIBLE FOR FINALIZING CONSTRUCTION DETAILING (VIA STAMPED SHOP DRAWINGS) DEPENDENT ON SURVEY AND FIELD-VERIFICATION OF EXISTING CONDITIONS SUCH AS UTILITIES, GRADES, ETC.
- 8. CONTRACTOR TO SUBMIT SHOP DRAWINGS WITH STRUCTURAL STAMP FOR LAYOUT AND CONSTRUCTION OF ALL VERTICAL HARDSCAPE ELEMENTS, INCLUDING SITE WALLS, STAIRS, RAILINGS, FENCING AND GATES, FOR REVIEW BY OWNER AND LANDSCAPE
- 9. IF PROPOSED SITE ELEMENTS ARE IN CONFLICT WITH EXISTING UTILITIES BASED ON CONTRACTOR'S FINDINGS, CONTRACTOR TO ALERT OWNER AND LANDSCAPE ARCHITECT IN WRITING TO DETERMINE ALTERNATE LOCATION.

610 W CONWAY STREET BALTIMORE, MD 21230 WARD 22, SECTION 060

PROJECT INFORMATION:

LANDSCAPE ARCHITECT: ENVIROCOLLAB, LLC 111 E 25TH STREET, SUITE 1A BALTIMORE, MD 21218 PHONE: 443-956-9278

LANDSCAPE ARCHITECTURE

ENGINEER:

CITYSCAPE ENGINEERING, LLC 3000 CHESTNUT AVE SUITE #112

BALTIMORE, MD 21211 PHONE: 410-601-3290

DEVELOPER/APPLICANT:

SOUTH BALTIMORE GATEWAY PARTNERSHIP 101 W. DICKMAN STREET

STE 1000 BALTIMORE, MD 21230

PHONE: XXX-XXX-XXXX

PROPERTY OWNER:

MAYOR AND CITY COUNCIL 100 N HOLLIDAY STREET

BALTIMORE, MD 21202

REVISION

DRAWN: JS

DESIGNED: JS, HT

BY DATE

CHECKED: HT, CO

COUNCIL DISTRICT #11

BLOCK 0861, LOT 005

ePLAN NO.: DECEMBER 2023

PROJECT NO.:

SHEET TITLE:

MATERIALS PLAN

> DWG. NO.: L102

FOR INFORMATION ONLY; NOT FOR CONSTRUCTION.

-/- E - _ _ BURGUNDY STREET / 0 0 0 0 SEE R.O.W. DRAWINGS

LAYOUT PLAN: PAVING

SCALE: 1" = 10'

LAYOUT LEGEND

CENTER LINE

\ ALIGN

— — — EXPANSION JOINT (@ CONCRETE PAVING)

CONTROL JOINT (@ CONCRETE PAVING)

LOW POINT

W TOP OF WAL

W BOTTOM OF WALL (@ FINISH GRADE)

BOTTOM OF CURB

TC TOP OF CURB

SLOPE DIRECTION

+ SPOT ELEVATION

POINT OF BEGINNING

LAYOUT NOTES.

- 1. REFER TO L-102 FOR HARDSCAPE MATERIALS PLAN AND
- L-103 FOR PAVING PLAN.
- 2. REFER TO L-301 FOR PLANTING PLAN.
- REFER TO ELECTRICAL DRAWINGS FOR SITE LIGHTING.
 THIS PLAN REFLECTS TOP OF WALL ELEVATIONS ONLY
- RELATES TO ADJACENT COURTYARD GRADE); REFER TO CIVIL DRAWINGS FOR EXISTING CONDITIONS AND TOPOGRAPHY, FINAL PAVING GRADES, AND ALL DRAIN LOCATIONS.
- 5. PAVER PATTERNS & PAVING SCORING (CONTROL JOINTS) SHOWN ON L-101 REPRESENT PATTERNS TO BE INSTALLED; ORIENT PATTERNS AS SHOWN. SEE DETAIL 1/L-201 FOR PAVER PATTERN ENLARGEMENT, AND 2/L-103 FOR CONCRETE PAVEMENT SCORING LAYOUT.
- 6. PROVIDE EXPANSION JOINTS ALONG ALL BUILDING, WALL, AND STAIR EDGES; REFER TO STRUCTURAL DRAWINGS.
- 7. EXPANSION JOINTS AT UNIT PAVERS ARE LOCATED IN SLAB BELOW; REFER TO STRUCTURAL DRAWINGS.
- 8. PROVIDE EXPANSION JOINTS ALONG ALL BUILDING, WALL, AND STAIR EDGES; REFER TO STRUCTURAL DRAWINGS.
- 9. CONTRACTOR TO SUBMIT SHOP DRAWINGS FOR LAYOUT AND CONSTRUCTION OF ALL SITE WALLS, STAIRS, RAILINGS, FENCING AND GATES FOR REVIEW BY ARCHITECT AND LANDSCAPE ARCHITECT.

FOR INFORMATION ONLY; NOT FOR CONSTRUCTION.

ENVIROCOLLAB, LLC 111 E 25TH STREET, SUITE 1A BALTIMORE, MD 21218 PHONE: 443-956-9278



LANDSCAPE ARCHITECT:

ENGINEER:
CITYSCAPE ENGINEERING, LLC
3000 CHESTNUT AVE
SUITE #112
BALTIMORE, MD 21211
PHONE: 410-601-3290



DEVELOPER/APPLICANT:

SOUTH BALTIMORE GATEWAY
PARTNERSHIP
101 W. DICKMAN STREET
STE 1000
BALTIMORE, MD 21230
PHONE: XXX-XXX-XXXX

PROPERTY OWNER:

MAYOR AND CITY COUNCIL 100 N HOLLIDAY STREET BALTIMORE, MD 21202

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ORAWN: JS CHECKED: HT, CO

DESIGNED: JS, HT

PROJECT INFORMATION:

610 W CONWAY STREET BALTIMORE, MD 21230 WARD 22, SECTION 060 BLOCK 0861, LOT 005

COUNCIL DISTRICT #11

ePLAN NO.: N/A

DATE: DECEMBER 2023

PROJECT NO.:

SHEET TITLE:

LAYOUT PLAN -PAVING

DWG. NO.:

L103

-/- E - _ _ BURGUNDY STREET / 0 0 0 SEE R.O.W. DRAWINGS

LAYOUT PLAN: SITE AMENITIES

SCALE: 1" = 10'

LAYOUT LEGEND

CENTER LINE

— — — EXPANSION JOINT (@ CONCRETE PAVING)

CONTROL JOINT (@ CONCRETE PAVING)

LOW POINT

BOTTOM OF WALL (@ FINISH GRADE)

BOTTOM OF CURB

TOP OF CURB

SLOPE DIRECTION

SPOT ELEVATION

POINT OF BEGINNING

LAYOUT NOTES.

LOCATIONS.

- 1. REFER TO L-102 FOR HARDSCAPE MATERIALS PLAN AND
- L-103 FOR PAVING PLAN.
- 2. REFER TO L-301 FOR PLANTING PLAN.
- 3. REFER TO ELECTRICAL DRAWINGS FOR SITE LIGHTING. 4. THIS PLAN REFLECTS TOP OF WALL ELEVATIONS ONLY
- RELATES TO ADJACENT COURTYARD GRADE); REFER TO CIVIL DRAWINGS FOR EXISTING CONDITIONS AND TOPOGRAPHY, FINAL PAVING GRADES, AND ALL DRAIN
- 5. PAVER PATTERNS & PAVING SCORING (CONTROL JOINTS) SHOWN ON L-101 REPRESENT PATTERNS TO BE INSTALLED; ORIENT PATTERNS AS SHOWN. SEE DETAIL 1/L-201 FOR PAVER PATTERN ENLARGEMENT, AND 2/L-103 FOR CONCRETE PAVEMENT SCORING LAYOUT.
- 6. PROVIDE EXPANSION JOINTS ALONG ALL BUILDING, WALL, AND STAIR EDGES; REFER TO STRUCTURAL DRAWINGS.
- 7. EXPANSION JOINTS AT UNIT PAVERS ARE LOCATED IN SLAB BELOW; REFER TO STRUCTURAL DRAWINGS.
- 8. PROVIDE EXPANSION JOINTS ALONG ALL BUILDING, WALL, AND STAIR EDGES; REFER TO STRUCTURAL DRAWINGS.
- 9. CONTRACTOR TO SUBMIT SHOP DRAWINGS FOR LAYOUT AND CONSTRUCTION OF ALL SITE WALLS, STAIRS, RAILINGS, FENCING AND GATES FOR REVIEW BY ARCHITECT AND LANDSCAPE ARCHITECT.

FOR INFORMATION ONLY; NOT FOR CONSTRUCTION.

LANDSCAPE ARCHITECT: ENVIROCOLLAB, LLC 111 E 25TH STREET, SUITE 1A BALTIMORE, MD 21218 PHONE: 443-956-9278



ENGINEER: CITYSCAPE ENGINEERING, LLC 3000 CHESTNUT AVE SUITE #112 BALTIMORE, MD 21211 PHONE: 410-601-3290



DEVELOPER/APPLICANT:

SOUTH BALTIMORE GATEWAY PARTNERSHIP 101 W. DICKMAN STREET STE 1000 BALTIMORE, MD 21230 PHONE: XXX-XXX-XXXX

PROPERTY OWNER:

MAYOR AND CITY COUNCIL 100 N HOLLIDAY STREET BALTIMORE, MD 21202

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CHECKED: HT, CO

DESIGNED: JS, HT

PROJECT INFORMATION:

610 W CONWAY STREET BALTIMORE, MD 21230 WARD 22, SECTION 060 BLOCK 0861, LOT 005

COUNCIL DISTRICT #11

ePLAN NO.: DECEMBER 2023

PROJECT NO.:

SHEET TITLE:

LAYOUT PLAN -**AMENITIES**

DWG. NO.:

L104



PRODUCT: SALVAGED BRICK PAVERS FROM EXISTING SITE PAVING IN R.O.W.

NEW BRICK TO MATCH.


SUPPLEMENT AS NEEDED WITH

NEW BRICK

MANUFACTURER:

1. SEE PLAN FOR LOCATION. 2. SEE L103 FOR PAVING

- PATTERN 3. SEE L102 FOR ALT.
- MATERIAL OPTION 4. PAVERS TO BE LAID ON 1" BITUMINOUS SETTING BED W/ 4" CONCRETE BASE &
- 4" COMPACTED, GRADED AGGREGATE SUBBASE. . PROVIDE STEEL EDGING OR FLUSH DECORATIVE CONCRETE BAND.

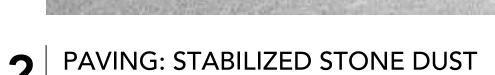



PRODUCT: CAST IN PLACE CONCRETE DECORATIVE SAWCUT PATTERN.

NOTES:

 SEE PLAN FOR LOCATION.

2. COMPACTED, GRADED AGGREGATE BASE

PAVING: CAST IN PLACE CONCRETE

PAVING: SALVAGED + NEW BRICK





PRODUCT:

10'L x 24"D x 18" H MOLDED CONCRETE SEATWALL ON CONCRETE SLAB

MANUFACTURER:

1. SEE PLAN FOR LOCATION.



BALTIMORE CITY STANDARD

CONWAY STREET PARK AND

TO MATCH EXISTING IN

1. SEE PLAN FOR

LOCATION.

DOT R.O.W.

HISTORIC DISTRICT POLE LIGHT

EMBEDDED MOUNT.

BALTIMORE CITY DOT.

PROVIDED AND

INSTALLED BY

STANDALONE BENCH

PRODUCT:

TBD

NOTES:

STABILIZED STONE DUST

COLOR: MEDIUMGRAY

MANUFACTURER:

SEE PLAN FOR

2. COMPACTED,

PROVIDE STEEL

LOCATION.

GRADED AGGREGATE

EDGING OR FLUSH

CONCRETE BAND

DECORATIVE

PRODUCT: MONOLINE SOLID SERIES BENCH, 6' L. (ML-SS-BENCH-72). THERMALLY MODIFIED ASH SLATS, ALUMINUM FRAME, CUSTOM POWDERCOAT FINISH (COLOR TBD). CUSTOMIZE WITH FULL BACKREST SLATS TO SEAT LEVEL.

MANUFACTURER: SITE PIECES DENVER, COLORADO SITEPIECES.COM 800.484.0797

 SEE PLAN FOR LOCATION.

2. SURFACE MOUNT.

PRECAST CONCRETE SEAT WALL



PRODUCT:

MONOLINE SOLID SERIES COMMUNITY TABLE, 144" L. (ML-SS-CMTEXT-144) THERMALLY MODIFIED ASH SLATS, ALUMINUM FRAME, CUSTOM POWDERCOAT FINISH (COLOR TBD). CUSTOMIZED FOR ONE-SIDE ADA ACCESS.

MANUFACTURER: SITE PIECES DENVER, COLORADO SITEPIECES.COM 800.484.0797

NOTES:

 SEE PLAN FOR LOCATION.

2. SURFACE MOUNT ON CONCRETE FOOTINGS BENEATH STONE DUST PRODUCT:

MONOLINE FLAT BENCH, NO ARMRESTS 6' L. (ML-FLAT-72). THERMALLY MODIFIED ASH SLATS, ALUMINUM FRAME, CUSTOM POWDERCOAT FINISH

MANUFACTURER: SITE PIECES

DENVER, COLORADO SITEPIECES.COM 800.484.0797

 SEE PLAN FOR LOCATION.

2. SURFACE MOUNT ON CONCRETE FOOTINGS BENEATH STONE DUST.

COMMUNITY TABLE W/ BENCHES

SCALE: N.T.S.

LIGHTING: POLE



STRING LIGHTING W/ WOODEN POSTS, 10' H.

MANUFACTURER: LIGHTING ENVIRONMENTS

NOTES:

1. SEE PLAN FOR LOCATION.
2. EMBEDDED MOUNT.

8 LIGHTING: STRING

FOR INFORMATION ONLY; NOT FOR CONSTRUCTION.

L201

PROPERTY OWNER: MAYOR AND CITY COUNCIL 100 N HOLLIDAY STREET BALTIMORE, MD 21202

BY DATE

LANDSCAPE ARCHITECT: ENVIROCOLLAB, LLC 111 E 25TH STREET, SUITE 1A BALTIMORE, MD 21218 PHONE: 443-956-9278

LANDSCAPE ARCHITECTURE

ENGINEER: CITYSCAPE ENGINEERING, LLC

3000 CHESTNUT AVE SUITE #112

BALTIMORE, MD 21211

PHONE: 410-601-3290

DEVELOPER/APPLICANT:

SOUTH BALTIMORE GATEWAY

PARTNERSHIP

101 W. DICKMAN STREET STE 1000

BALTIMORE, MD 21230

PHONE: XXX-XXX-XXXX

CHECKED: HT, CO DRAWN: JS DESIGNED: JS, HT

REVISION

PROJECT INFORMATION:

610 W CONWAY STREET BALTIMORE, MD 21230 WARD 22, SECTION 060 BLOCK 0861, LOT 005

COUNCIL DISTRICT #11

ePLAN NO.: DECEMBER 2023

PROJECT NO.: SHEET TITLE:


> HARDSCAPE DETAILS

DWG. NO.:

PLANTING LEGEND

√PA√

PLANTING AREA (40% SHRUBS, 60% PERENNIALS + GRASSES)

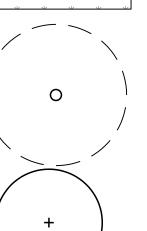

EXISTING SHADE TREE TO BE PRESERVED

PROPOSED SHADE TREE

PROPOSED ORNAMENTAL TREE

PROPOSED SPECIES PALETTE



Dwarf Virginia Sweetspire

Dwarf Summersweet

Dwarf Winterberry

Dwarf Witch-Alder

Pennsylvania Sedge

Blonde Ambition' Grama Grass

Tufted Hairgrass

Northern Sea-Oats

Foxglove Beardtongue

Frosted Violet' Coral Bells

October Skies' Aromatic Aster

Sweet-Scented Joe Pye Weed

Little Goldstar' Black-Eyed Susan #1

Little Bluestem

Butterflyweed

Switchgrass

Aromatic Sumac

PROPOSED TREE PLANTING:

Itea virginica 'Little Henry'

Rhus aromatica 'Gro-Low'

DCE Deschampsia cespitosa 'Goldtau'

PVI Panicum virgatum 'Shenandoah'

BGB Bouteloua gracilis 'Blonde Ambition'

SSS Schizachyrium scoparium 'Standing Ovation'

SYO Symphiotrichum oblongifolium 'October Skies'

Fothergilla gardenii

ORNAMENTAL GRASSES, SEDGES, + RUSHES.

CLA Chasmanthium latifolum

HFR Heuchera 'Frosted Violet'

CPE Carex pensylvanica

PDI Penstemon digitalis

AST Asclepias tuberosa

EUP Eutrochium purpureum

RFU Rudbeckia fulgida 'Little Goldstar'

Clethra alnifolia 'Sugartina Crystalina'

llex verticillata 'Red Sprite/Jim Dandy'

SHRUBS.

PERENNIALS.



























XX XX SEE R.O.W. DRAWINGS

24" ht., 3' O.C.

18" O.C.

Cont.

#3

#3

#3

PLANTING NOTES.

- 1. THE CONTRACTOR SHALL PROVIDE ALL MATERIALS, LABOR AND EQUIPMENT TO COMPLETE ALL LANDSCAPE WORK AS SHOWN ON THE CONTRACT
- 2. ALL PLANT MATERIALS SHALL CONFORM TO THE SIZES GIVEN IN THE PLANT LIST AND SHALL BE NURSERY GROWN IN ACCORDANCE WITH THE "AMERICAN STANDARD FOR NURSERY STOCK," LATEST EDITION. ANY PLANT MATERIAL EXHIBITING A SPINDLY OR LOP-SIDED HABIT OR ANY OTHER FEATURE THAT DETRACTS FROM ITS HEALTH OR APPEARANCE WILL BE REJECTED.
- 3. ALL PLANTING OPERATIONS SHALL BE IN ACCORDANCE WITH STANDARD AMERICAN ASSOCIATION OF NURSERYMEN PROCEDURES AND SPECIFICATIONS.
- UTILITIES WITHIN THE LANDSCAPED AREA PRIOR TO INSTALLATION OF ANY PLANT MATERIAL. IF CONDITIONS ARISE IN THE FIELD WHICH NECESSITATE SHIFTING OF THE PLANT MATERIAL, THE LANDSCAPE ARCHITECT IS TO BE
- 5. OBTAIN WRITTEN APPROVAL FROM LANDSCAPE ARCHITECT BEFORE MAKING
- 6. PRECAUTIONS SHALL BE TAKEN TO AVOID DAMAGE TO EXISTING CONDITIONS, INCLUDING PLANTS, TURF, PAVING, AND STRUCTURES DURING PLANTING
- 7. ALL AREAS DISTURBED BY CONSTRUCTION, GRADING, OR PLANTING OPERATIONS SHALL BE FINE GRADED AND PLANTED PER PLAN. SOD OR SEED
- 8. PLACE PLANTS FOR BEST APPEARANCE FOR REVIEW AND FINAL ORIENTATION BY LANDSCAPE ARCHITECT.
- 9. ALL PLANT BEDS SHALL BE CONTAINED WITH A 4" DEEP SPACED EDGE UNLESS OTHERWISE NOTED ON DRAWINGS.
- 10. ALL PLANT BEDS AND PLANTING AREAS TO BE MULCHED TO A DEPTH OF 2"
- 8. ALL DEBRIS AND WASTE MATERIAL RESULTING FROM PLANTING OPERATIONS SHALL BE CLEANED UP, REMOVED FROM THE PROJECT SITE, AND DISPOSED OF

- 4. CONTRACTOR SHALL VERIFY THE CORRECT LOCATION OF ALL UNDERGROUND CONSULTED PRIOR TO RELOCATION.
- ANY SUBSTITUTIONS OR CHANGES.
- OPERATIONS. ANY DAMAGED AREAS SHALL BE RESTORED TO THEIR ORIGINAL
- ANY DISTURBED AREAS NOT INDICATED AS RECEIVING PLANTS OR PAVING.
- UNLESS OTHERWISE NOTED ON DRAWINGS OR SPECIFICATIONS.
- PROPERLY.

ePLAN NO.: DECEMBER 2023 PROJECT NO.: SHEET TITLE:

PLANTING PLAN

PROJECT INFORMATION:

610 W CONWAY STREET

BALTIMORE, MD 21230 WARD 22, SECTION 060

BLOCK 0861, LOT 005

COUNCIL DISTRICT #11

LANDSCAPE ARCHITECT: ENVIROCOLLAB, LLC 111 E 25TH STREET, SUITE 1A BALTIMORE, MD 21218 PHONE: 443-956-9278

enviro collab LANDSCAPE ARCHITECTURE

ENGINEER:

CITYSCAPE ENGINEERING, LLC 3000 CHESTNUT AVE

BALTIMORE, MD 21211 PHONE: 410-601-3290

DEVELOPER/APPLICANT: SOUTH BALTIMORE GATEWAY

PARTNERSHIP 101 W. DICKMAN STREET STE 1000 BALTIMORE, MD 21230

PHONE: XXX-XXX-XXXX

PROPERTY OWNER:

MAYOR AND CITY COUNCIL 100 N HOLLIDAY STREET

BALTIMORE, MD 21202

REVISION

DRAWN: JS

DESIGNED: JS, HT


BY DATE

CHECKED: HT, CO

DWG. NO.: L301


PLANTING PLAN SCALE: 1" = 10'


FOR INFORMATION ONLY; NOT FOR CONSTRUCTION.

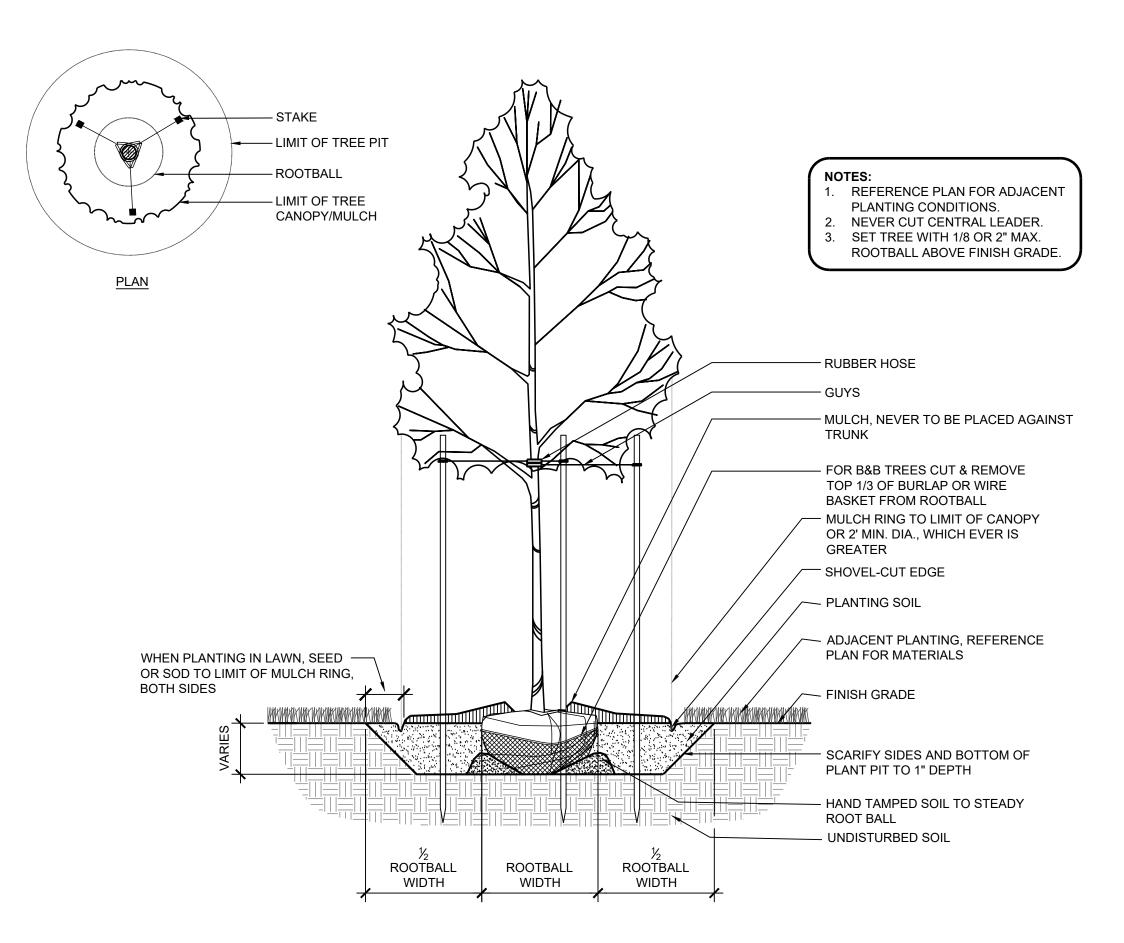

SINGLE STEM SHADE TREE PLANTING

SCALE: 1"= 1/2'-0'

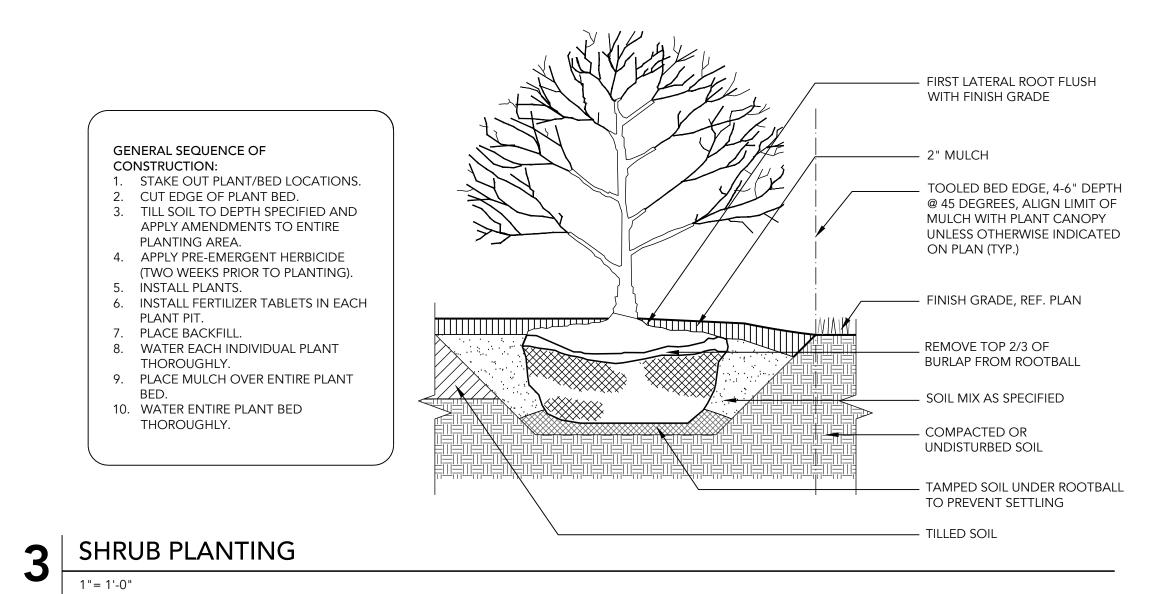

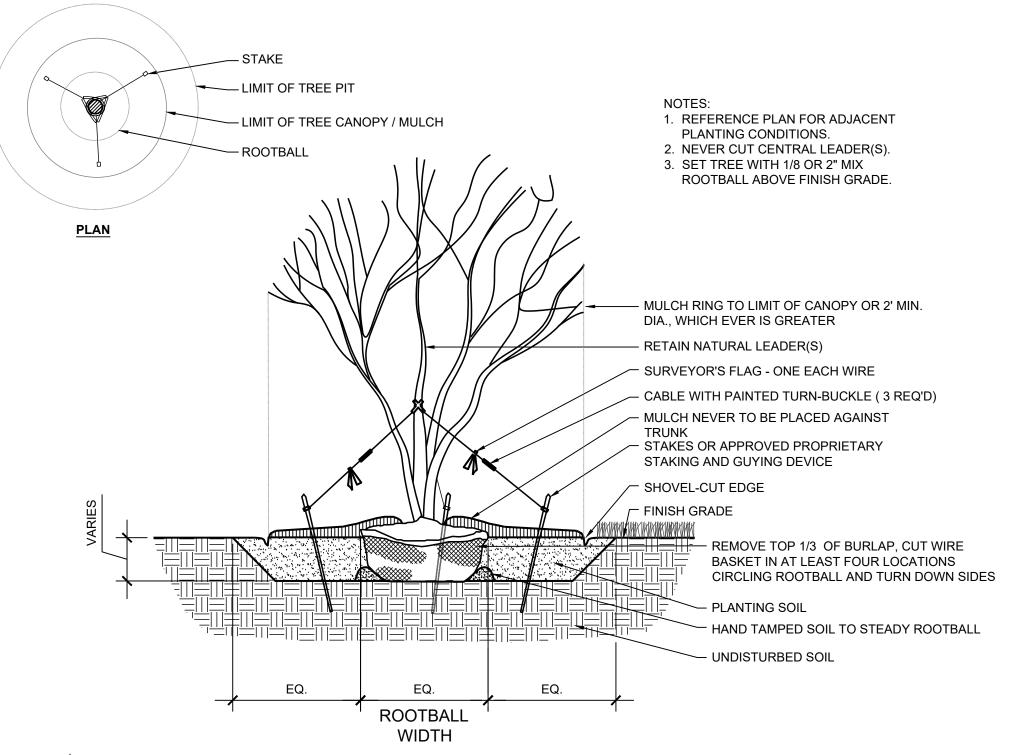

2 ORNAMENTAL TREE PLANTING

PLAN

GROUNDCOVER, PERENNIAL, OR ORNAMENTAL GRASS TYP.

GROUNDCOVER, PERENNIAL, OR ORNAMENTAL GRASS TYP.

GROUNDCOVER, PERENNIAL, OR ORNAMENTAL GRASS TYP.

2" MULCH

PLANTING SOIL

UNDISTURBED SUB-GRADE

GROUNDCOVER PLANTING

SCALE: 1"= 1'-0"

LANDSCAPE ARCHITECT:

ENVIROCOLLAB, LLC

111 E 25TH STREET, SUITE 1A
BALTIMORE, MD 21218
PHONE: 443-956-9278



ENGINEER:
CITYSCAPE ENGINEERING, LLC
3000 CHESTNUT AVE
SUITE #112
BALTIMORE, MD 21211
PHONE: 410-601-3290



DEVELOPER/APPLICANT:

SOUTH BALTIMORE GATEWAY
PARTNERSHIP
101 W. DICKMAN STREET
STE 1000
BALTIMORE, MD 21230
PHONE: XXX-XXX-XXXX

PROPERTY OWNER:

MAYOR AND CITY COUNCIL 100 N HOLLIDAY STREET BALTIMORE, MD 21202

NO.	REVISION	BY	DATE
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DRAWN: JS CHECKED: HT, CO
DESIGNED: JS, HT

PROJECT INFORMATION:

610 W CONWAY STREET BALTIMORE, MD 21230 WARD 22, SECTION 060 BLOCK 0861, LOT 005

COUNCIL DISTRICT #11

DATE: DECEMBER 2023

PROJECT NO.: N/A

ePLAN NO.:

SHEET TITLE:

PLANTING DETAILS

FOR INFORMATION ONLY; NOT FOR CONSTRUCTION.

DWG. NO.:

SOIL PREPARATION NOTES.

THESE NOTES SERVE AS A GENERAL GUIDE ONLY, PER CSI SPECIFICATION SECTION 329113 (SOIL PREPARATION); REFER TO EROSION AND SEDIMENT CONTROL NOTES, SHEET C-303 FOR DETAILED INSTRUCTIONS ON SITE CLEARING, EROSION CONTROL, SOIL STORAGE, TESTING, PRODUCTS AND EXECUTION PROCEDURES.

- 1. THE CONTRACTOR SHALL ENGAGE A QUALIFIED TESTING AGENCY TO PERFORM PRECONSTRUCTION SOIL ANALYSIS ON EXISTING, ON-SITE SOIL AND IMPORTED SOIL. SOIL ANALYSIS/REPORT TO PROVIDE RECOMMENDATIONS ON: SOIL AMENDMENT, INCLUDING RECOMMENDATIONS FOR NITROGEN, PHOSPHORUS, AND POTASSIUM FERTILIZATION, AND FOR MICRONUTRIENTS; FERTILIZERS; SOIL-FERTILITY ANALYSIS ACCORDING TO SSSA NAPT SERA-6; AND ORGANIC MATTER CONTENT ACCORDING TO SSSA'S METHOD OF SOIL ANALYSIS PART 3 CHEMICAL METHODS. RECOMMENDATIONS TO BE PROVIDED IN WEIGHT PER 1000 SF FOR 6 INCH DEPTH OF SOIL
- 2. SOIL MATERIALS TO BE DELIVERED PACKAGED IN ORIGINAL, UNOPENED CONTAINERS SHOWING WEIGHT, CERTIFIED ANALYSIS, NAME AND ADDRESS OF MANUFACTURER, AND COMPLIANCE WITH STATE AND FEDERAL LAWS IF APPLICABLE; APPROPRIATE CERTIFICATES TO ACCOMPANY DELIVERY OF BULK FERTILIZERS AND AMENDMENTS.
- 3. DO NOT DUMP/STORE BULK MATERIALS NEAR STRUCTURES, UTILITIES, PAVEMENT, OR EXISTING TURF OR PLANT AREAS; PROVIDE EROSION CONTROL MEASURES AS NEEDED.
- 4. BASED ON SOIL AGENCY RECOMMENDATION, PROVIDE EITHER AMENDED ON-SITE SURFACE SOIL, OR IMPORTED MANUFACTURER SOIL CONSISTING OF MANUFACTURER'S BASIC SANDY LOAM ACCORDING TO USDA TEXTURES, BLENDED IN A FACILITY WITH SAND, STABILIZED ORGANIC SOIL AMENDMENTS, AND OTHER MATERIALS TO PRODUCE VIABLE PLANTING SOIL. SOIL MUST NOT CONTAIN ANY EXTRANEOUS MATERIALS THAT COULD BE HARMFUL TO PLANT GROWTH, NOR ANY STONES, ROOTS, POCKETS OF COURSE SAND, ETC., EXCEEDING 1 ½ INCHES IN ANY DIMENSION.
- 5. BLEND EITHER AMENDED ONSITE SOIL OR IMPORTED SOIL WITH LOOSE COMPACT TO SOIL RATIO OF 1:4 BY VOLUME.
 6. APPLY INORGANIC AND ORGANIC SOIL AMENDMENTS AND FERTILIZERS PER RECOMMENDATION OF QUALIFIED SOIL TESTING
- 7. FOR EITHER PLACING AND MIXING PLANTING SOIL OVER EXPOSED SUBGRADE, OR PLACING MANUFACTURED PLANTING SOIL OVER EXPOSED SUBGRADE: TILL SUBGRADE TO A MINIMUM DEPTH OF 8 INCHES; APPLY HALF OF THICKNESS OF PLANTING SOIL OVER PREPARED, LOOSENED SUBGRADE, MIXING INTO TOP 4 INCHES OF SUBGRADE; SPREAD REMAINDER OF PLANTING SOIL TO TOTAL DEPTH INDICATED ON DRAWINGS, BUT NOT LESS THAN REQUIRED TO MEET FINISH GRADES AFTER NATURAL SETTLEMENT; COMPACT EACH LIFT OF PLANTING SOIL TO 75 TO 82 PERCENT OF MAXIMUM STANDARD PROCTOR DENSITY ACCORDING TO ASTM D698 EXCEPT WHERE DIFFERENT COMPACTON IS INDICATED ON DRAWINGS; GRADE PLANTING SOIL TO A SMOOTH, UNIFORM SURFACE PLANE WITH LOOSE, UNIFORMLY FINE TEXTURE; AND ROLL AND RAKE TO REMOVE RIDGES AND FILL DEPRESSIONS TO MEET FINISH GRADES.
- 8. IDENTIFY PROTECTION ZONES ACCORDING TO SECTION 015639 (TEMPORARY TREE AND PLANT PROTECTION), AND PROHIBIT PRACTICES IN THESE AREAS SUCH AS STORAGE OF MATERIALS, PARKING VEHICLES OR EQUIPMENT, VEHICLE OR FOOT TRAFFIC, ERECTION OF STRUCTURES, IMPOUNDMENT OF WATER, AND EXCAVATION.
- 9. IF PLANTING SOIL OR SUBGRADE IS OVERCOMPACTED, DISTURBED, OR CONTAMINATED BY FOREIGN OR DELETERIOUS MATERIALS OR LIQUIDS, REMOVE THE PLANTING SOIL AND CONTAMINATION AND RESTORE SUBGRADE AND REPLACE CONTAMINATED PLANTING SOIL WITH NEW PLANTING SOIL.
- 10. PROTECT AREAS ADJACENT TO PLANTING SOIL PREPARATION AND PLACEMENT AREAS FROM CONTAMINATION. KEEP ADJACENT PAVING AND CONSTRUCTION CLEAN AND WORK AREA IN AN ORDERLY CONDITION.
- 11. REMOVE SURPLUS SOIL AND WASTE MATERIAL INCLUDING EXCESS SUBSOIL, UNSUITABLE MATERIALS, TRASH, AND DEBRIS AND LEGALLY DISPOSE OF THEM OFF OWNER'S PROPERTY UNLESS OTHERWISE INDICATED.

PLANTING NOTES.

- 1. THE CONTRACTOR SHALL PROVIDE ALL MATERIALS, LABOR AND EQUIPMENT TO COMPLETE ALL LANDSCAPE WORK AS SHOWN ON THE PLANS AND SPECIFICATIONS.
- 2. ALL PLANT MATERIALS SHALL CONFORM TO THE SIZES GIVEN IN THE PLANT LIST AND SHALL BE NURSERY GROWN IN ACCORDANCE WITH THE "AMERICAN STANDARD FOR NURSERY STOCK," LATEST EDITION. ANY PLANT MATERIAL EXHIBITING A
- SPINDLY OR LOP-SIDED HABIT OR ANY OTHER FEATURE THAT DETRACTS FROM ITS HEALTH OR APPEARANCE WILL BE REJECTED.

 3. ALL PLANTING SHALL BE IN ACCORDANCE WITH STANDARD AMERICAN ASSOCIATION OF NURSERYMEN PROCEDURES AND
- CONTRACTOR SHALL VERIFY THE CORRECT LOCATION OF ALL UNDERGROUND UTILITIES WITHIN THE LANDSCAPED AREA PRIOR
 TO INSTALLATION OF ANY PLANT MATERIAL. IF CONDITIONS ARISE IN THE FIELD WHICH NECESSITATES SHIFTING OF THE PLANT
 MATERIAL, THE LANDSCAPE ARCHITECT IS TO BE CONSULTED PRIOR TO RELOCATION.
- 5. OBTAIN WRITTEN APPROVAL FROM LANDSCAPE ARCHITECT BEFORE MAKING ANY SUBSTITUTIONS OR CHANGES.
- 6. PRECAUTIONS SHALL BE TAKEN TO AVOID DAMAGE TO EXISTING PLANTS, TURF AND STRUCTURES. ANY DAMAGED AREAS SHALL BE RESTORED TO THEIR ORIGINAL CONDITIONS. ALL AREAS DISTURBED BY PLANTING OR GRADING OPERATIONS SHALL BE FINE GRADED AND SEEDED OR SODDED. ALL DEBRIS AND WASTE MATERIAL RESULTING FROM PLANTING OPERATIONS SHALL BE
- REMOVED FROM THE PROJECT AND CLEANED UP.
 7. PLACE PLANTS FOR BEST APPEARANCE FOR REVIEW AND FINAL ORIENTATION BY LANDSCAPE ARCHITECT.
- PLACE PLANTS FOR BEST APPEARANCE FOR REVIEW AND FINAL ORIENTATION BY LANDSCAPE ARCHITECT.
 ALL PLANT BEDS SHALL BE CONTAINED WITH A 4" DEEP SPACED EDGE UNLESS OTHERWISE NOTED ON DRAWINGS.
- 9. ALL PLANT BEDS AND PLANTING AREAS TO BE MULCHED TO A DEPTH OF 2" UNLESS OTHERWISE NOTED ON DRAWINGS OR SPECIFICATIONS.

MAINTENANCE.

REQUIRED LANDSCAPING MUST BE KEPT ALIVE AND HEALTHY TO CONTINUE TO MEET THE REQUIREMENTS OF THE BALTIMORE CITY LANDSCAPE MANUAL AND THE ZONING CODE. PROPER MAINTENANCE AND IRRIGATION MUST BE PROVIDED FOR ALL INSTALLED LANDSCAPING.

THE MAINTENANCE OF PLANTS INSTALLED IS REQUIRED FOR SUCCESSFUL LANDSCAPING. PLANTS CANNOT BE INSTALLED AND LEFT ALONE, ESPECIALLY IN URBAN ENVIRONMENTS WHERE THEY MAY BE SUBJECT TO HIGH TEMPERATURES, HARSH ENVIRONMENTS, AND PHYSICAL ABUSE. GIVEN THE STRESSES AND RIGORS TO WHICH PLANTS ARE SUBJECTED, PLANTS MAY REQUIRE REPLACEMENT. A TWO-YEAR REPLACEMENT WARRANTY IS REQUIRED FOR ALL PLANTS AND A MAINTENANCE CONTRACT IS ENCOURAGED TO PROMOTE THE ESTABLISHMENT OF PLANTS AND ENCOURAGE PROPER LANDSCAPE MAINTENANCE. BEYOND THE WARRANTY PERIOD, THE CONTINUED MAINTENANCE OF THE LANDSCAPE IS THE RESPONSIBILITY OF THE PROPERTY OWNER FOR THE LIFE OF THE PROJECT.

REQUIREMENTS FOR LANDSCAPE MAINTENANCE ARE AS FOLLOWS:

- MAINTENANCE OF LANDSCAPED AREAS INCLUDES, BUT IS NOT LIMITED TO WEEDING, MULCHING, MOWING, TRIMMING, PRUNING, EDGING, CULTIVATION, SEEDING, FERTILIZATION, WATERING, PEST CONTROL, AND ANY OTHER
- MAINTENANCE NECESSARY TO ENSURE HEALTHY, VIGOROUS PLANT GROWTH AND WELL-KEPT PROPERTY CONDITION.
 LANDSCAPING ELEMENTS SUCH AS WALLS AND FENCES SHALL BE CONSTRUCTED IN A SOUND WORKMANLIKE MANNER WITH ADEQUATE SUPPORT OR FOOTINGS AND MUST BE REPAIRED OR REPLACED AS NEEDED TO PRESERVE AN ATTRACTIVE APPEARANCE AND TO FUNCTION AS INTENDED.
- ANY DEAD PLANTS OR PLANTS WHICH FAIL TO SHOW HEALTHY GROWTH MUST BE REMOVED AND REPLACED WITHIN 60
 DAYS OF IDENTIFICATION OF DETERIORATED HEALTH OR NOTIFICATION BY THE CITY. REPLACEMENT MAY BE DELAYED
 UNTIL THE NEXT GROWING SEASON ONLY IF THE 60 DAY PERIOD OCCURS DURING A TIME OF YEAR NOT SUITABLE FOR
 PLANTING.
- ALL REPLACEMENT PLANTS MUST MEET THE SIZE AND OTHER CHARACTERISTICS OF NEWLY PLANTED MATERIAL AS REQUIRED IN THE MANUAL.
- TREES AND LARGE SHRUBS MUST BE ADEQUATELY SUPPORTED, WHEN NECESSARY TO INSURE PROPER GROWTH. TREE STAKING MUST BE REMOVED PRIOR TO FINAL INSPECTION, WITH THE EXCEPTION OF PLANTS REPLACED DURING THE WARRANTY PERIOD AND NOT YET ESTABLISHED.
- IT IS DESIRABLE TO AVOID EXCESSIVE USE OF FERTILIZERS, HERBICIDES, AND PESTICIDES TO MINIMIZE IMPACTS ON WATER QUALITY. IT IS RECOMMENDED THAT FERTILIZER APPLICATION BE NEED-BASED RATHER THAN AS AN AUTOMATIC COMPONENT OF MAINTENANCE SCHEDULES AND WHEN APPROPRIATE, SLOW-RELEASE OR NATURAL FERTILIZERS BE SELECTED OVER HIGHLY-SOLUBLE CHEMICAL FERTILIZERS.
- APPLICATION OF HERBICIDES AND PESTICIDES SHALL BE PERFORMED BY A CERTIFIED PROFESSIONAL ONLY.
- THE IMPLEMENTATION OF AN INTEGRATED PEST MANAGEMENT (IPM) PROGRAM IS RECOMMENDED TO PREVENT AND TREAT PEST PROBLEMS.

IRRIGATION.

ALL PLANTS NEED SUPPLEMENTAL WATER DURING THE FIRST AND SECOND GROWING SEASONS TO ESTABLISH THEIR ROOT SYSTEMS; HOWEVER, A PERMANENT IRRIGATION SYSTEM IS NOT REQUIRED. A GENERAL GUIDELINE FOR ESTABLISHMENT IS TO PROVIDE IRRIGATION AT A RATE OF ONE INCH OF WATER PER WEEK, INCLUDING THAT THROUGH RAINFALL. RECOMMENDED TECHNIQUES TO REDUCE WATER REQUIREMENTS AND APPROVED METHODS FOR THE PROVISION OF WATER SUPPLY TO PLANTS INCLUDE THE FOLLOWING:

IRRIGATION METHODS.

- 1. THE USE AND MAINTENANCE OF DRIP IRRIGATION BAGS OR RINGS AROUND THE TRUNKS OF NEWLY-PLANTED TREES.
- 2. HAND WATERING, WITH WATER SOURCES PROVIDED THROUGH EITHER OR BOTH OF THE FOLLOWING METHODS:
 - EXTERIOR FAUCETS ON A BUILDING, LOCATED SO THAT THE FARTHEST PLANTING CAN BE REACHED BY A LENGTH
 OF HOSE (100 FEET RECOMMENDED).
 - A QUICK-COUPLING SYSTEM, WITH CONNECTIONS LOCATED SO THAT THE FARTHEST PLANTING CAN BE REACHED BY A LENGTH OF HOSE (100 FEET RECOMMENDED).
 - A WATER TANK OR TRUCK.
- 3. AN AUTOMATIC IRRIGATION SYSTEM WITH A MOISTURE-SENSING DEVICE AND/OR RAIN SHUT-OFF SWITCH. IF USING AN AUTOMATIC IRRIGATION SYSTEM, THE FOLLOWING REQUIREMENTS SHALL BE MET:
 - ALL IRRIGATION SYSTEMS SHALL BE DESIGNED TO MINIMIZE VANDALISM.
 - SPRINKLERS MUST NOT OVER-SPRAY ONTO PAVEMENT. SPRINKLER AND SPRAY HEADS ARE NOT PERMITTED FOR PLANTING AREAS LESS THAN 8 FEET IN WIDTH, TO PREVENT OVERSPRAY AND RUN-OFF. OTHER IRRIGATION METHODS SHALL BE SPECIFIED IN SUCH AREAS.
 - PLACE LAWN AREAS IN A SEPARATE IRRIGATION ZONE FROM SHRUB AND GROUNDCOVER BEDS, SO THAT EACH
 PLANTING TYPE CAN RECEIVE ADEQUATE IRRIGATION WITHOUT OVER-WATERING AREAS WITH LOWER IRRIGATION
 NEEDS.
 - DRIP IRRIGATION IS RECOMMENDED FOR SHRUB AND GROUNDCOVER BEDS. DRIP IRRIGATION SHALL BE USED IN AREAS SMALLER THAN FIVE FEET IN ANY DIRECTION.
- 4. THE USE OF RAINWATER HARVESTING TECHNIQUES COMBINED WITH THE USE OF HARVESTED RAINWATER FOR LANDSCAPE IRRIGATION IS ENCOURAGED.

LANDSCAPE ARCHITECT:

ENVIROCOLLAB, LLC

111 E 25TH STREET, SUITE 1A
BALTIMORE, MD 21218

PHONE: 443-956-9278



ENGINEER:

CITYSCAPE ENGINEERING, LLC
3000 CHESTNUT AVE
SUITE #112

BALTIMORE, MD 21211
PHONE: 410-601-3290



DEVELOPER/APPLICANT

SOUTH BALTIMORE GATEWAY
PARTNERSHIP
101 W. DICKMAN STREET
STE 1000
BALTIMORE, MD 21230
PHONE: XXX-XXX-XXXX

PROPERTY OWNER:

MAYOR AND CITY COUNCIL 100 N HOLLIDAY STREET BALTIMORE, MD 21202

NO.	REVISION	BY	DATE
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DRAWN: JS CHECKED: HT, CO

DESIGNED: JS, HT

PROJECT INFORMATION:

610 W CONWAY STREET BALTIMORE, MD 21230 WARD 22, SECTION 060 BLOCK 0861, LOT 005

COUNCIL DISTRICT #11

ePLAN NO.: N/A

DATE: DECEMBER 2023


PROJECT NO.:


PLANTING NOTES

SHEET TITLE:

FOR INFORMATION ONLY; NOT FOR CONSTRUCTION.

DWG. NO.: L402

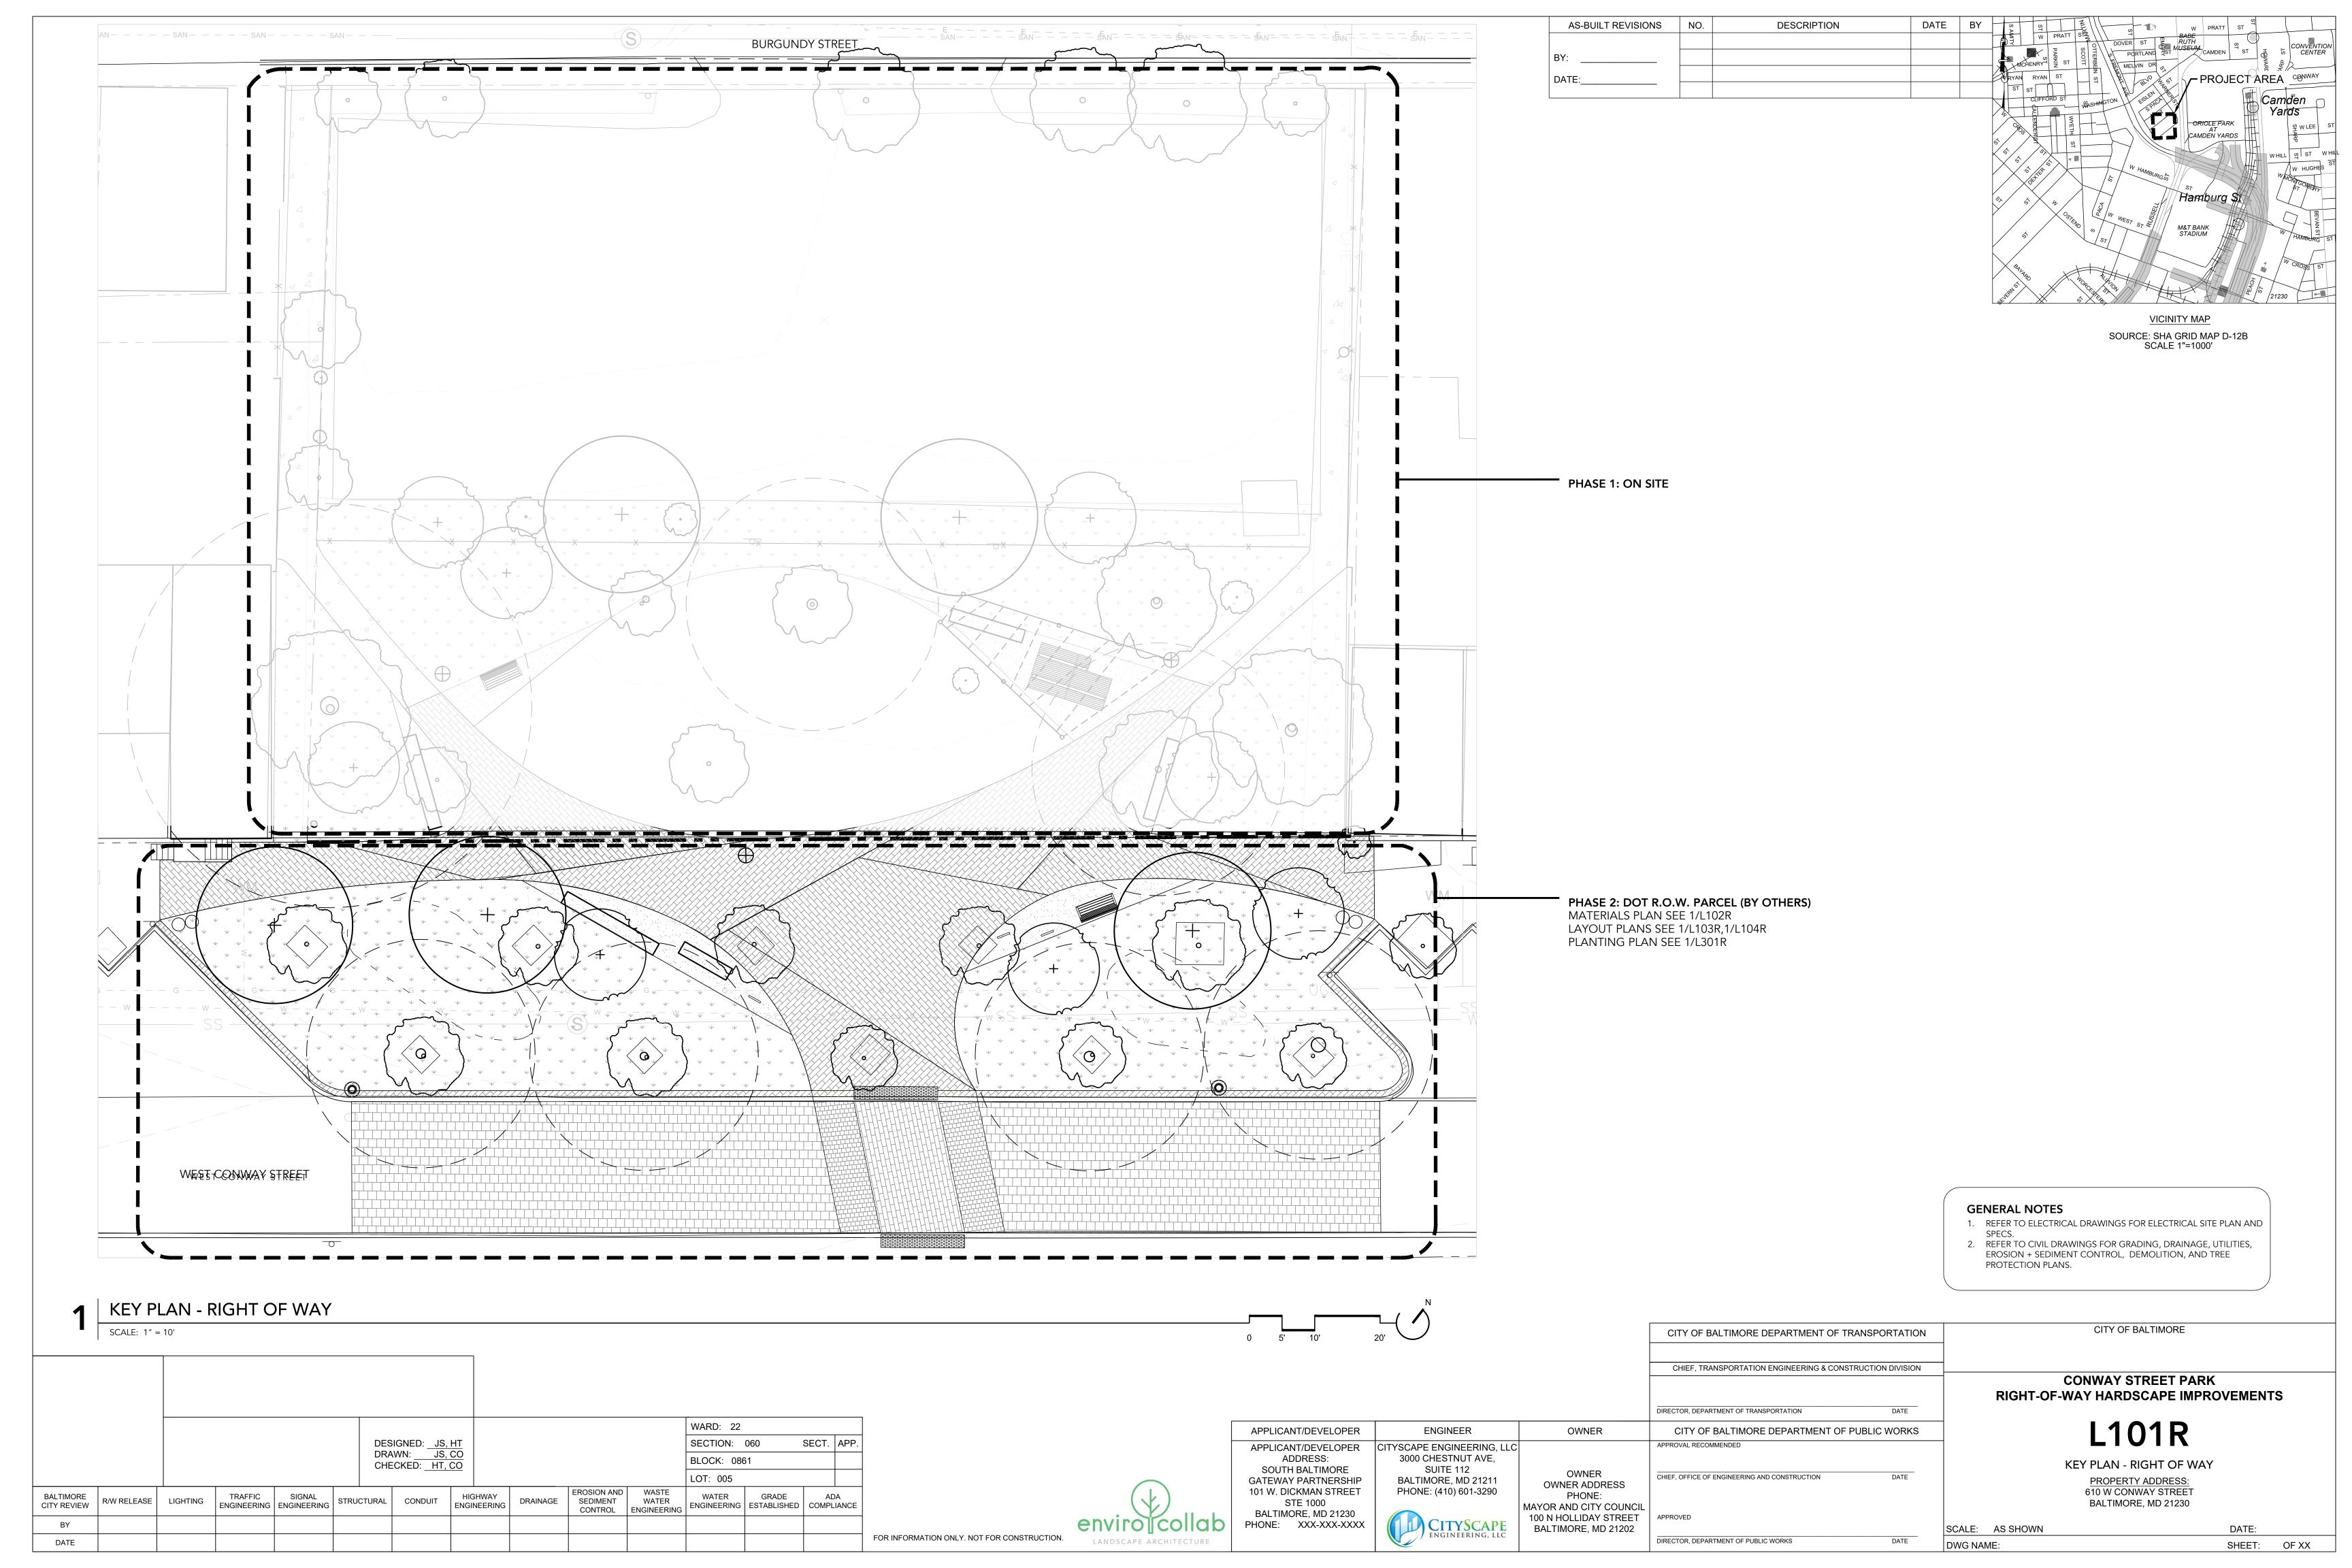

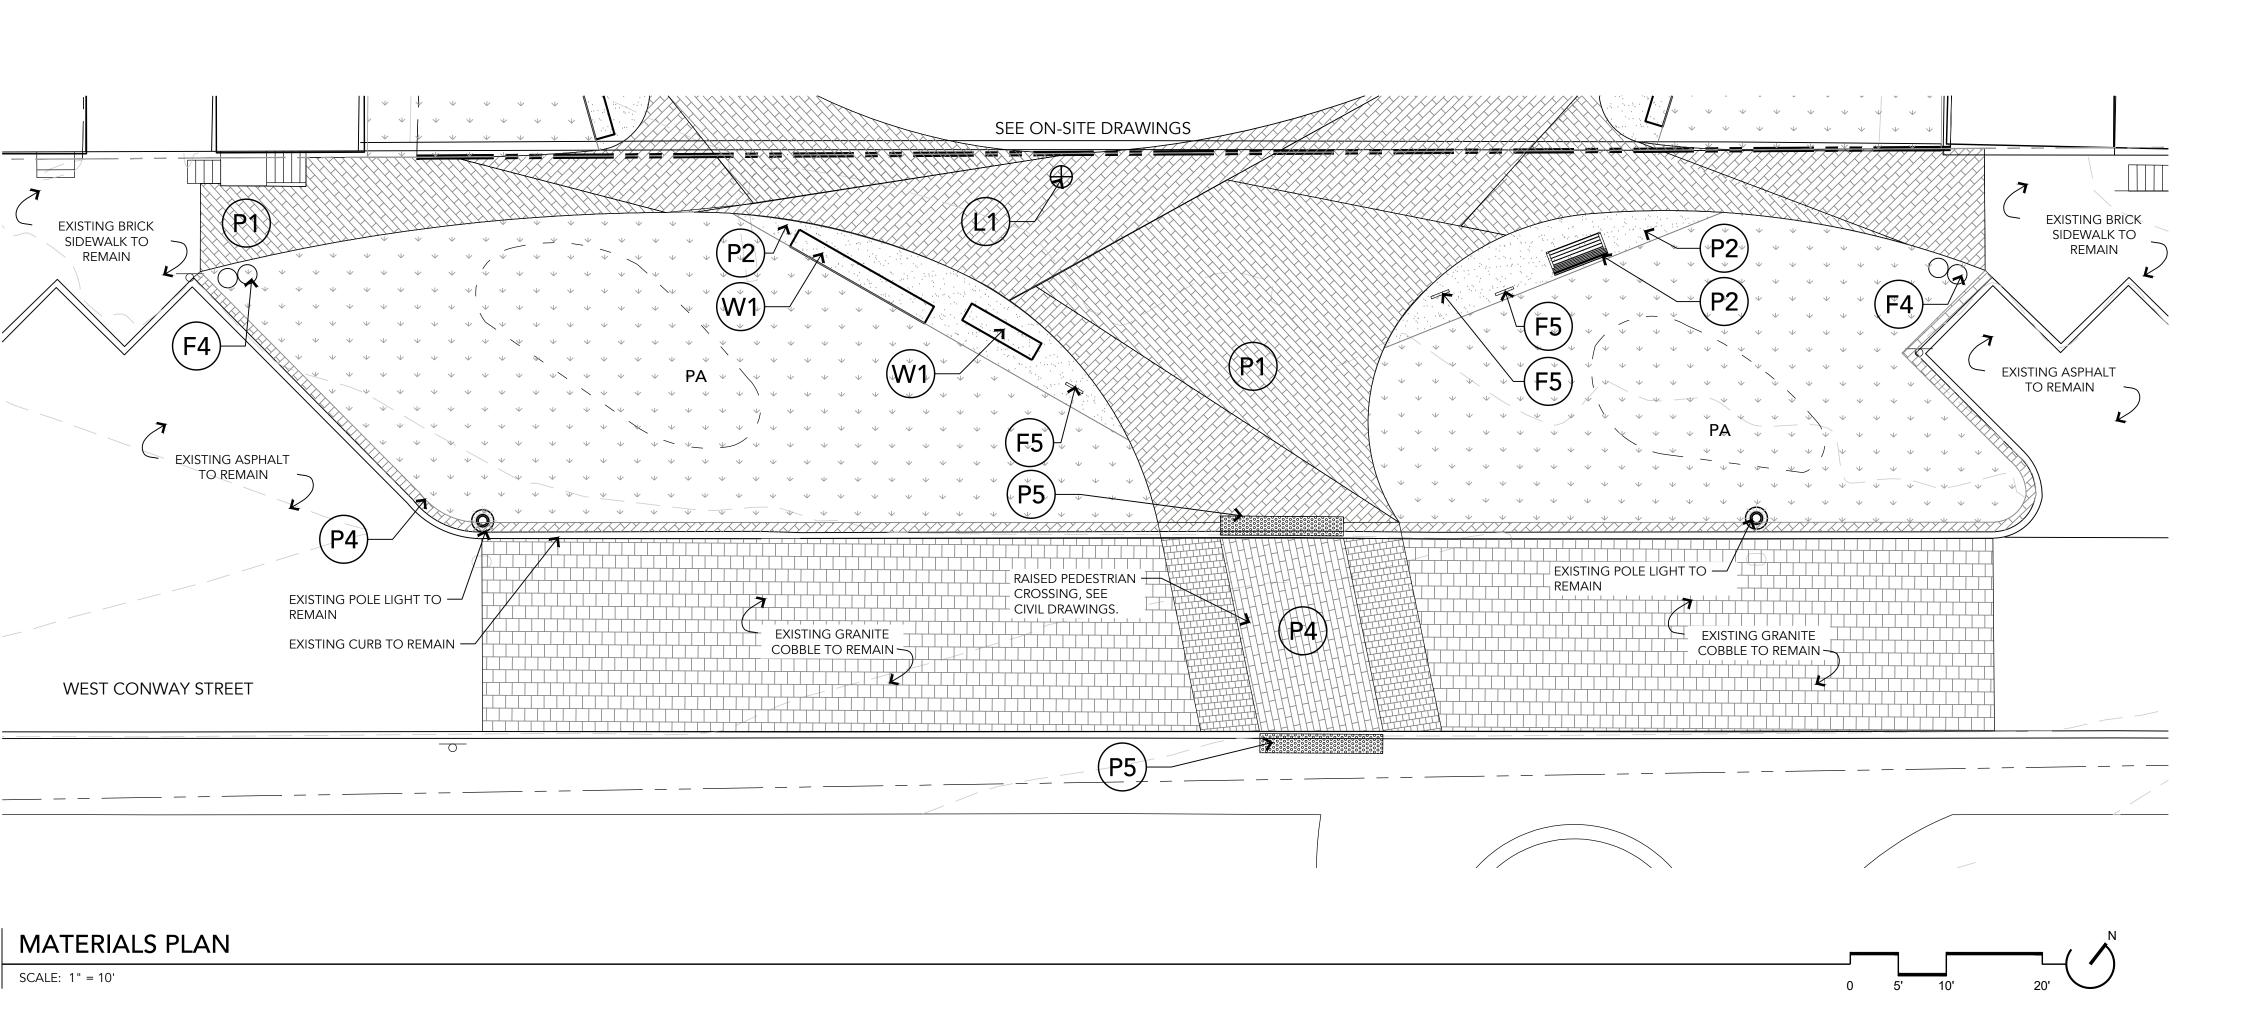

WARD: 22

SECTION: 060

WATER GRADE

ENGINEERING ESTABLISHED COMPLIANCE

BLOCK: 0861

LOT: 005

EROSION AND WASTE

CONTROL ENGINEERING

WATER

SEDIMENT

DRAINAGE

ENGINEERING

SECT. APP.

DESIGNED: JS, HT

DRAWN: JS, CO
CHECKED: HT, CO

ENGINEERING ENGINEERING STRUCTURAL CONDUIT

R/W RELEASE LIGHTING

CITY REVIEW

DATE

HARDSCAPE & AMENITIES LEGEND

PAVING.

1 BRICK PAVING: CUSTOM PATTERN

4"x8"x 2 \frac{3}{4}" SALVAGED AND REUSED PAVER LAID IN CUSTOM PATTERN ON BITUMINOUS SETTING BED W/ CONCRETE BASE

(P1) ALT 1 NEW BRICK

(P1) ALT 2
4"THICK SCORED DECORATIVE CONCRETE PAVING ON COMPACTED GRADED AGGREGATE BASE




STONE DUST PAVING
OVER COMPACTED AGGREGATE




CONCRETE PAVING

4" THICK SCORED CONCRETE PAVING ON 4" COMPACTED, GRADED AGGREGATE SUBBASE

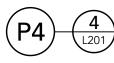

4 BRICK PAVING: STANDARD RUNNING BOND

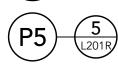

DETECTABLE WARNING PAVERS

2' WIDE MIN. TRUNCATED DOME PAVER AREA
AT CURB RAMP TRANSITION: CUT PAVERS TO FI AT CURB RAMP TRANSITION; CUT PAVERS TO FIT

WALLS & CURBS.



PRECAST CONCRETE SEAT WALL

10'L x 24"D x 18" H MOLDED CONCRETE

SEATWALL ON CONCRETE SLAB SEATWALL ON CONCRETE SLAB

FURNISHINGS & FEATURES.



WOOD + METAL BENCH
PREFABRICATED;XXXXXX
APPROX. 6' L APPROX. 6' L



8 LITTER/RECYCLING RECEPTACLE PREFABRICATED; SURFACE MOUNT



BIKE RACK PREFABRICATED; SURFACE MOUNT

LIGHTING.



10 POLE LIGHT
12' HEIGHT DECO 12' HEIGHT DECORATIVE POLES

MATERIALS NOTES:

- 1. PA = PLANTING AREA; REFER TO L-301 FOR PLANTING PLAN. 2. REFER TO ELECTRICAL DRAWINGS FOR ELECTRICAL SITE PLAN
- 3. REFER TO CIVIL DRAWINGS FOR GRADING, DRAINAGE, UTILITIES, EROSION + SEDIMENT CONTROL, DEMOLITION, AND TREE PROTECTION PLANS.
- 4. REFER TO CIVIL DRAWINGS FOR RAISED PEDESTRIAN CROSSING 5. CONTRACTOR TO SUBMIT SAMPLES AND PRODUCT INFORMATION FOR ALL PAVING, WALLS, AND FURNISHINGS FOR REVIEW BY
- LANDSCAPE ARCHITECT. 6. CONTRACTOR TO SUBMIT SHOP DRAWINGS FOR LAYOUT AND CONSTRUCTION OF ALL SITE WALLS, STAIRS, RAILINGS, FENCING
- AND GATES FOR REVIEW BY ARCHITECT AND LANDSCAPE ARCHITECT. 7. REFER TO L103 AND L104 FOR LAYOUT + GRADING INFORMATION,
- L200 SERIES FOR HARDSCAPE DETAILS, AND L300 SERIES FOR PLANTING PLANS.
- 8. THIS DRAWING PACKAGE INCLUDES INFORMATION TO CONVEY MATERIALS SELECTIONS AND DESIGN INTENT INFORMATION. CONTRACTOR IS RESPONSIBLE FOR FINALIZING CONSTRUCTION DETAILING (VIA STAMPED SHOP DRAWINGS) DEPENDENT ON SURVEY AND FIELD-VERIFICATION OF EXISTING CONDITIONS SUCH AS UTILITIES, GRADES, ETC.
- 9. CONTRACTOR TO SUBMIT SHOP DRAWINGS WITH STRUCTURAL STAMP FOR LAYOUT AND CONSTRUCTION OF ALL VERTICAL HARDSCAPE ELEMENTS, INCLUDING SITE WALLS, STAIRS, RAILINGS, FENCING AND GATES, FOR REVIEW BY OWNER AND LANDSCAPE
- 10. IF PROPOSED SITE ELEMENTS ARE IN CONFLICT WITH EXISTING UTILITIES BASED ON CONTRACTOR'S FINDINGS, CONTRACTOR TO ALERT OWNER AND LANDSCAPE ARCHITECT IN WRITING TO DETERMINE ALTERNATE LOCATION.

	CITY OF BALTIMORE DEPARTMENT OF TRANSPORTATION	
	CHIEF, TRANSPORTATION ENGINEERING & CONSTRUCTION DIVISION	
	DIRECTOR, DEPARTMENT OF TRANSPORTATION DATE	
OWNER	CITY OF BALTIMORE DEPARTMENT OF PUBLIC WORKS	
	APPROVAL RECOMMENDED	
OWNER	CHIEF, OFFICE OF ENGINEERING AND CONSTRUCTION DATE	
NER ADDRESS PHONE:		
AND CITY COUNCIL		
HOLLIDAY STREET IMORE. MD 21202	APPROVED	SCALE:
	1	JUCALE.

CONWAY STREET PARK RIGHT-OF-WAY HARDSCAPE IMPROVEMENTS

CITY OF BALTIMORE

MATERIALS PLAN PROPERTY ADDRESS: 610 W CONWAY STREET BALTIMORE, MD 21230

SHEET: OF XX

FOR INFORMATION ONLY. NOT FOR CONSTRUCTION.

GATEWAY PARTNERSHIP 101 W. DICKMAN STREET STE 1000 BALTIMORE, MD 21230 PHONE: XXX-XXX-XXXX

APPLICANT/DEVELOPER

APPLICANT/DEVELOPER

ADDRESS:

SOUTH BALTIMORE

SUITE 112 BALTIMORE, MD 21211 PHONE: (410) 601-3290

ENGINEER

CITYSCAPE ENGINEERING, LLC


3000 CHESTNUT AVE,

OWNER ADDRE PHONE: MAYOR AND CITY 100 N HOLLIDAY

BALTIMORE, MD 21202

DIRECTOR, DEPARTMENT OF PUBLIC WORKS

AS SHOWN

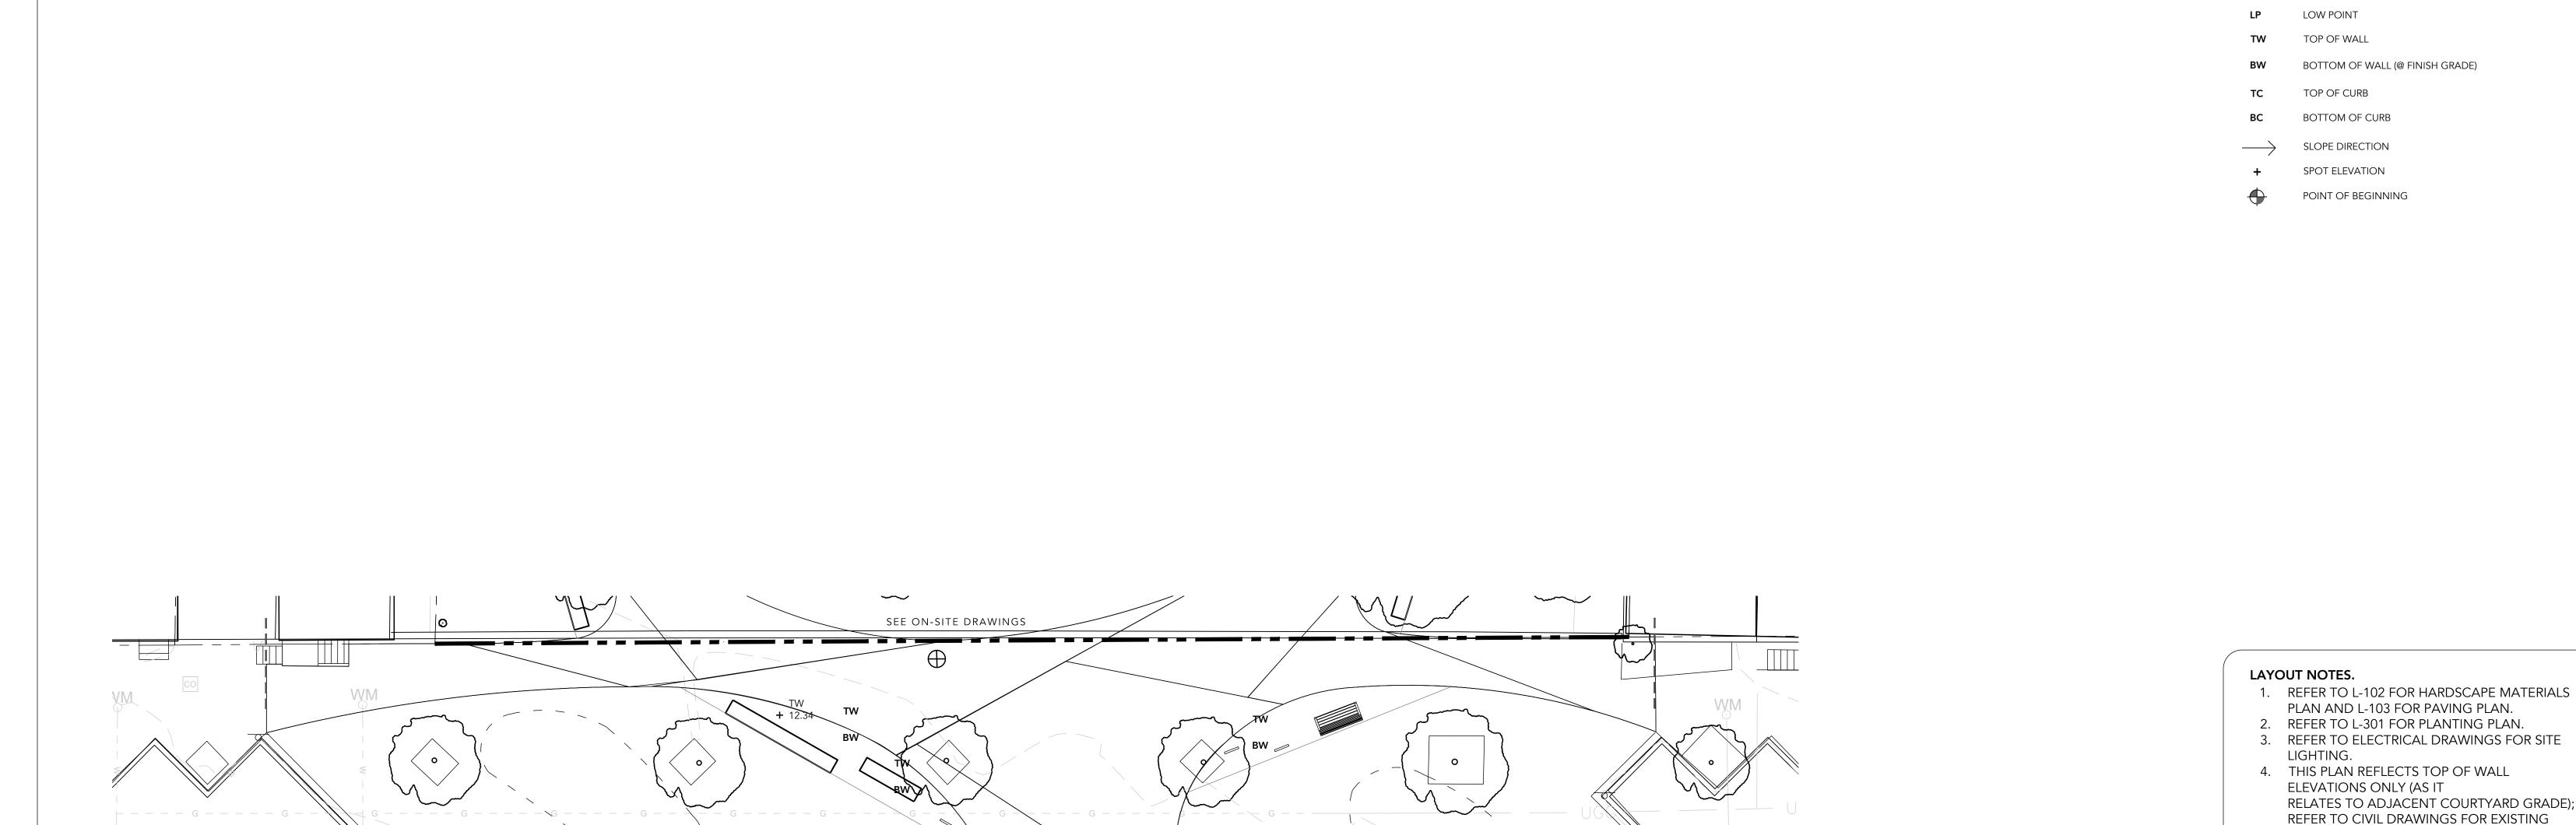

LAYOUT PLAN: PAVING

WEST CONWAY STREET

WARD: 22 SECTION: 060 SECT. APP.

DESIGNED: JS, HT
DRAWN: JS, CO
CHECKED: HT, CO BLOCK: 0861 LOT: 005 EROSION AND WASTE ENGINEERING SIGNAL STRUCTURAL CONDUIT WATER GRADE R/W RELEASE LIGHTING DRAINAGE SEDIMENT WATER CITY REVIEW ENGINEERING ENGINEERING ESTABLISHED COMPLIANCE CONTROL ENGINEERING DATE

FOR INFORMATION ONLY. NOT FOR CONSTRUCTION.

APPLICANT/DEVELOPER ADDRESS: SOUTH BALTIMORE GATEWAY PARTNERSHIP 101 W. DICKMAN STREET STE 1000 BALTIMORE, MD 21230 PHONE: XXX-XXX-XXXX

APPLICANT/DEVELOPER

CITYSCAPE ENGINEERING, LLC 3000 CHESTNUT AVE, SUITE 112 BALTIMORE, MD 21211 PHONE: (410) 601-3290

ENGINEER

OWNER OWNER ADDRESS PHONE: MAYOR AND CITY COUNCIL 100 N HOLLIDAY STREET BALTIMORE, MD 21202

OWNER

CITY OF BALTIMORE DEPARTMENT OF PUBLIC WORKS APPROVAL RECOMMENDED CHIEF, OFFICE OF ENGINEERING AND CONSTRUCTION

DIRECTOR, DEPARTMENT OF PUBLIC WORKS

CONWAY STREET PARK RIGHT-OF-WAY HARDSCAPE IMPROVEMENTS

CITY OF BALTIMORE

L103R

PROPERTY ADDRESS: 610 W CONWAY STREET BALTIMORE, MD 21230

SHEET: OF XX

DIRECTOR, DEPARTMENT OF TRANSPORTATION

CITY OF BALTIMORE DEPARTMENT OF TRANSPORTATION

CHIEF, TRANSPORTATION ENGINEERING & CONSTRUCTION DIVISION

LAYOUT PLAN: PAVING

LAYOUT LEGEND

© CENTER LINE

— — — EXPANSION JOINT (@ CONCRETE PAVING)

LOW POINT

TOP OF CURB

BOTTOM OF CURB

SLOPE DIRECTION

SPOT ELEVATION

POINT OF BEGINNING

CONTROL JOINT (@ CONCRETE PAVING)

BOTTOM OF WALL (@ FINISH GRADE)

PLAN AND L-103 FOR PAVING PLAN.

PAVING GRADES, AND ALL DRAIN

5. PAVER PATTERNS & PAVING SCORING

(CONTROL JOINTS) SHOWN ON L-101 REPRESENT PATTERNS TO BE INSTALLED; ORIENT PATTERNS AS SHOWN. SEE DETAIL 1/L-201 FOR PAVER PATTERN ENLARGEMENT, AND 2/L-103 FOR CONCRETE PAVEMENT

6. PROVIDE EXPANSION JOINTS ALONG ALL

7. EXPANSION JOINTS AT UNIT PAVERS ARE

8. PROVIDE EXPANSION JOINTS ALONG ALL

TO STRUCTURAL DRAWINGS.

TO STRUCTURAL DRAWINGS.

LANDSCAPE ARCHITECT.

BUILDING, WALL, AND STAIR EDGES; REFER

BELOW; REFER TO STRUCTURAL DRAWINGS.

BUILDING, WALL, AND STAIR EDGES; REFER

9. CONTRACTOR TO SUBMIT SHOP DRAWINGS FOR LAYOUT AND CONSTRUCTION OF ALL SITE WALLS, STAIRS, RAILINGS, FENCING AND

GATES FOR REVIEW BY ARCHITECT AND

RELATES TO ADJACENT COURTYARD GRADE); REFER TO CIVIL DRAWINGS FOR EXISTING CONDITIONS AND TOPOGRAPHY, FINAL

ELEVATIONS ONLY (AS IT


LIGHTING.

LOCATIONS.

SCORING LAYOUT.

LOCATED IN SLAB

SCALE: AS SHOWN

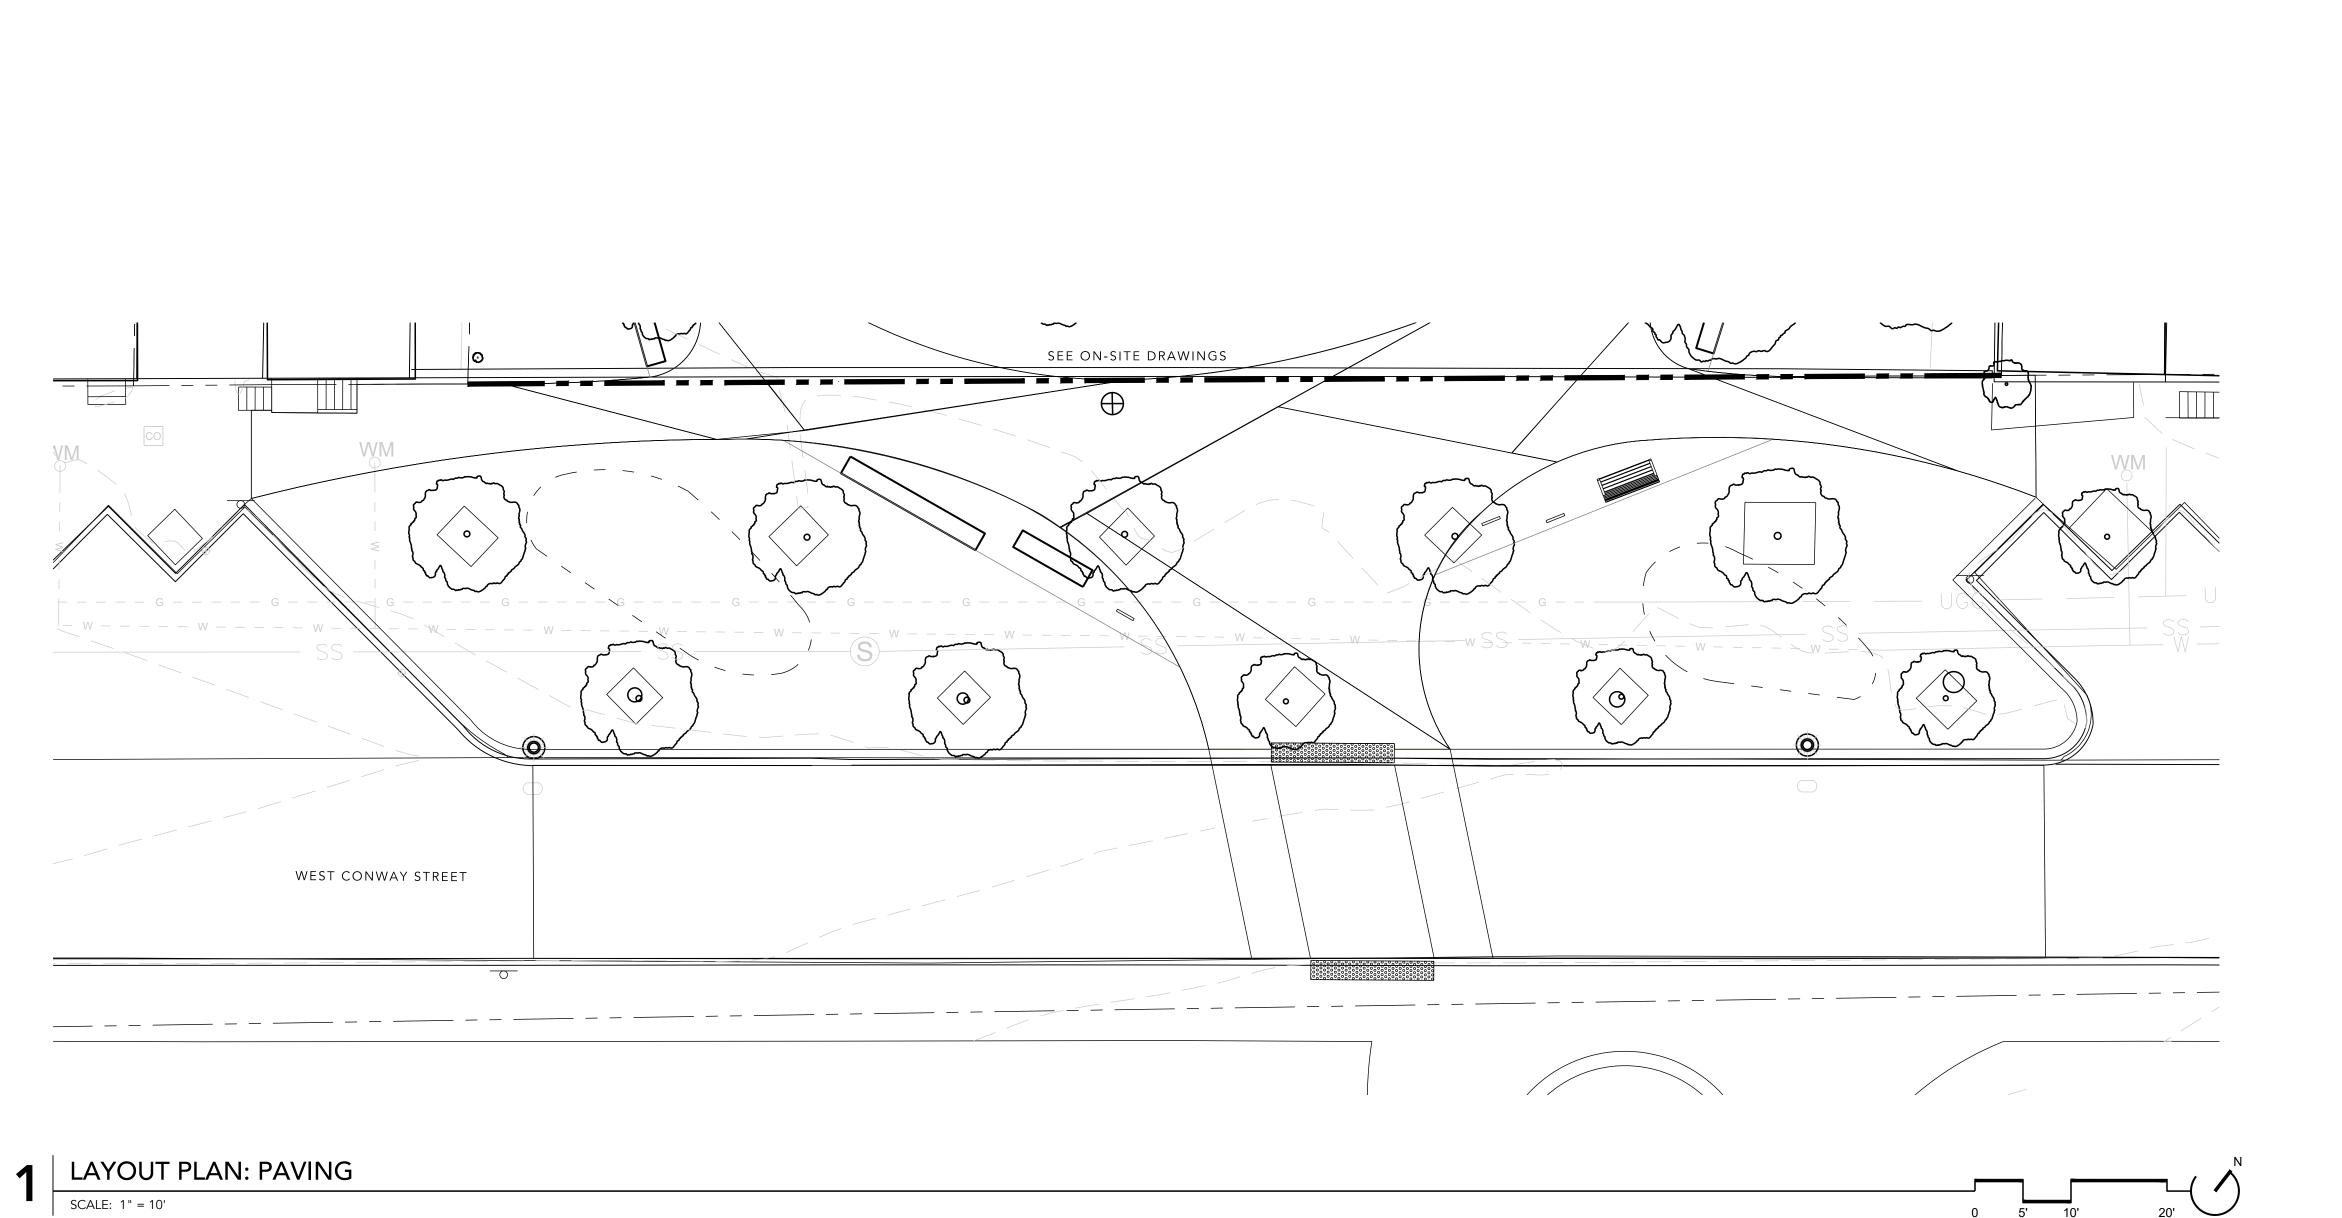

WARD: 22

SECTION: 060

WATER GRADE

ENGINEERING ESTABLISHED COMPLIANCE

BLOCK: 0861

LOT: 005

EROSION AND WASTE

CONTROL ENGINEERING

WATER

SEDIMENT

DRAINAGE

ENGINEERING

SECT. APP.

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DESIGNED: JS, HT
DRAWN: JS, CO
CHECKED: HT, CO

ENGINEERING SIGNAL STRUCTURAL CONDUIT

R/W RELEASE LIGHTING

CITY REVIEW

DATE

LAYOUT LEGEND

© CENTER LINE — — — EXPANSION JOINT (@ CONCRETE PAVING) CONTROL JOINT (@ CONCRETE PAVING) LOW POINT BOTTOM OF WALL (@ FINISH GRADE) TOP OF CURB **BOTTOM OF CURB** SLOPE DIRECTION

SPOT ELEVATION

POINT OF BEGINNING

- LAYOUT NOTES.
- 1. REFER TO L-102 FOR HARDSCAPE MATERIALS PLAN AND L-103 FOR PAVING PLAN.
- 2. REFER TO L-301 FOR PLANTING PLAN.
- 3. REFER TO ELECTRICAL DRAWINGS FOR SITE LIGHTING. 4. THIS PLAN REFLECTS TOP OF WALL
- ELEVATIONS ONLY (AS IT RELATES TO ADJACENT COURTYARD GRADE); REFER TO CIVIL DRAWINGS FOR EXISTING CONDITIONS AND TOPOGRAPHY, FINAL PAVING GRADES, AND ALL DRAIN LOCATIONS.
- 5. PAVER PATTERNS & PAVING SCORING (CONTROL JOINTS) SHOWN ON L-101 REPRESENT PATTERNS TO BE INSTALLED; ORIENT PATTERNS AS SHOWN. SEE DETAIL 1/L-201 FOR PAVER PATTERN ENLARGEMENT, AND 2/L-103 FOR CONCRETE PAVEMENT SCORING LAYOUT.
- 6. PROVIDE EXPANSION JOINTS ALONG ALL BUILDING, WALL, AND STAIR EDGES; REFER TO STRUCTURAL DRAWINGS.
- 7. EXPANSION JOINTS AT UNIT PAVERS ARE LOCATED IN SLAB
- BELOW; REFER TO STRUCTURAL DRAWINGS. 8. PROVIDE EXPANSION JOINTS ALONG ALL BUILDING, WALL, AND STAIR EDGES; REFER TO STRUCTURAL DRAWINGS.
- 9. CONTRACTOR TO SUBMIT SHOP DRAWINGS FOR LAYOUT AND CONSTRUCTION OF ALL SITE WALLS, STAIRS, RAILINGS, FENCING AND GATES FOR REVIEW BY ARCHITECT AND LANDSCAPE ARCHITECT.

CITY OF BALTIMORE DEPARTMENT OF TRANSPORTATION CHIEF, TRANSPORTATION ENGINEERING & CONSTRUCTION DIVISION DIRECTOR, DEPARTMENT OF TRANSPORTATION CITY OF BALTIMORE DEPARTMENT OF PUBLIC WORKS APPROVAL RECOMMENDED CHIEF, OFFICE OF ENGINEERING AND CONSTRUCTION OWNER ADDRESS MAYOR AND CITY COUNCIL 100 N HOLLIDAY STREET

DIRECTOR, DEPARTMENT OF PUBLIC WORKS

ENGINEER

CITYSCAPE ENGINEERING, LLC 3000 CHESTNUT AVE,

SUITE 112

BALTIMORE, MD 21211

PHONE: (410) 601-3290

OWNER

OWNER

PHONE:

BALTIMORE, MD 21202

APPLICANT/DEVELOPER

APPLICANT/DEVELOPER

ADDRESS:

SOUTH BALTIMORE

GATEWAY PARTNERSHIP

101 W. DICKMAN STREET

STE 1000

BALTIMORE, MD 21230

PHONE: XXX-XXX-XXXX

CONWAY STREET PARK RIGHT-OF-WAY HARDSCAPE IMPROVEMENTS

CITY OF BALTIMORE

L104R

LAYOUT PLAN: SITE AMENITIES PROPERTY ADDRESS: 610 W CONWAY STREET BALTIMORE, MD 21230

SCALE: AS SHOWN

SHEET: OF XX



PRODUCT:

SALVAGED BRICK PAVERS FROM EXISTING SITE PAVING IN R.O.W. SUPPLEMENT AS NEEDED WITH NEW BRICK TO MATCH.

NEW BRICK (PRODUCT AND MANUFACTURER TBD)

NOTES:

- 1. SEE PLAN FOR LOCATION. 2. SEE L103 FOR PAVING
- PATTERN 3. SEE L102 FOR ALT.
- MATERIAL OPTION 4. PAVERS TO BE LAID ON 1" BITUMINOUS SETTING BED
- W/ 4" CONCRETE BASE & 4" COMPACTED, GRADED AGGREGATE SUBBASE.
- PROVIDE STEEL EDGING OR FLUSH DECORATIVE CONCRETE BAND.

PAVING: STABILIZED STONE DUST



PRODUCT: CAST IN PLACE CONCRETE DECORATIVE SAWCUT PATTERN.

 SEE PLAN FOR LOCATION. 2. COMPACTED, GRADED

AGGREGATE BASE

PAVING: CAST IN PLACE CONCRETE



PAVING: SALVAGED + NEW BRICK

PRODUCT: $4" \times 8" \times 2\frac{3}{4}$ " BRICK PAVERS MANUFACTURER:

SEE PLAN FOR LOCATION.

PAVING: BRICK, STANDARD RUNNING BOND



PRODUCT:ADA TACTILE WARNING **PAVERS MANUFACTURER**

 SEE PLAN FOR LOCATION.

TACTILE WARNING PAVERS



PRECAST CONCRETE SEAT WALL

10'L x 24"D x 18" H MOLDED CONCRETE SEATWALL ON CONCRETE SLAB

MANUFACTURER:

. SEE PLAN FOR LOCATION.

STANDALONE BENCH

PRODUCT: MONOLINE SOLID SERIES BENCH, 6' L. (ML-SS-BENCH-72). THERMALLY MODIFIED ASH SLATS, ALUMINUM FRAME, CUSTOM POWDERCOAT FINISH (COLOR TBD). CUSTOMIZE WITH FULL BACKREST SLATS TO SEAT LEVEL.

SITE PIECES DENVER, COLORADO SITEPIECES.COM 800.484.0797

MANUFACTURER:

 SEE PLAN FOR LOCATION. 2. SURFACE MOUNT.



PRODUCT: MONOLINE DUO BIKE RACKS, CUSTOM FINISH.

MANUFACTURER: SITE PIECES DENVER, COLORADO SITEPIECES.COM 800.484.0797

1. SEE PLAN FOR LOCATION. 2. SURFACE MOUNT

BIKE RACK

NOTES:



BALTIMORE CITY STANDARD HISTORIC DISTRICT POLE LIGHT TO MATCH EXISTING IN R.O.W.

1. SEE PLAN FOR

LOCATION. 2. EMBEDDED MOUNT. PROVIDED AND

INSTALLED BY BALTIMORE CITY DOT.

POLE LIGHT

N.T.S.



PRODUCT: STEELSITES COLLECTION NSDC-36 WASTE AND RECYCLING RECEPTACLES. CUSTOM FINISH.

MANUFACTURER: **VICTOR STANLEY** DUNKIRK, MD VICTORSTANLEY.COM 301.855.8300

 SEE PLAN FOR LOCATION. SURFACE MOUNT.

10 LITTER + RECYCLING RECEPTACLES

											<u> </u>				
												WARD: 22			
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												LOT: 005			
BALTIMORE CITY REVIEW	R/W RELEASE	LIGHTING	TRAFFIC ENGINEERING	SIGNAL ENGINEERING	STRUCTURAL	CONDUIT		GHWAY INEERING	DRAINAGE	EROSION AND SEDIMENT CONTROL	WASTE WATER ENGINEERING	WATER ENGINEERING	GRADE ESTABLISHED	AD COMPL	
BY															
DATE								_							

FOR INFORMATION ONLY. NOT FOR CONSTRUCTION.

APPLICANT/DEVELOPER APPLICANT/DEVELOPER ADDRESS: SOUTH BALTIMORE GATEWAY PARTNERSHIP 101 W. DICKMAN STREET STE 1000 BALTIMORE, MD 21230 PHONE: XXX-XXX-XXXX

ENGINEER CITYSCAPE ENGINEERING, LLC 3000 CHESTNUT AVE, SUITE 112 BALTIMORE, MD 21211 PHONE: (410) 601-3290

OWNER OWNER OWNER ADDRESS PHONE:

CHIEF, TRANSPORTATION ENGINEERING & CONSTRUCTION DIVISION DIRECTOR, DEPARTMENT OF TRANSPORTATION CITY OF BALTIMORE DEPARTMENT OF PUBLIC WORKS APPROVAL RECOMMENDED CHIEF, OFFICE OF ENGINEERING AND CONSTRUCTION MAYOR AND CITY COUNCIL 100 N HOLLIDAY STREET

CITY OF BALTIMORE DEPARTMENT OF TRANSPORTATION

CONWAY STREET PARK RIGHT-OF-WAY HARDSCAPE IMPROVEMENTS L201R HARDSCAPE DETAILS

PROPERTY ADDRESS: 610 W CONWAY STREET BALTIMORE, MD 21230

CITY OF BALTIMORE

BALTIMORE, MD 21202 SCALE: AS SHOWN DATE: DIRECTOR, DEPARTMENT OF PUBLIC WORKS SHEET: OF XX



PLANTING PLAN - ROW

WARD: 22 DESIGNED: JS, HT
DRAWN: JS, CO
CHECKED: HT, CO SECTION: 060 SECT. APP. BLOCK: 0861 LOT: 005 EROSION AND ENGINEERING SIGNAL STRUCTURAL CONDUIT WATER GRADE R/W RELEASE LIGHTING SEDIMENT WATER ENGINEERING ESTABLISHED COMPLIANCE CITY REVIEW ENGINEERING CONTROL ENGINEERING

FOR INFORMATION ONLY. NOT FOR CONSTRUCTION.

APPLICANT/DEVELOPER APPLICANT/DEVELOPER ADDRESS: SOUTH BALTIMORE GATEWAY PARTNERSHIP 101 W. DICKMAN STREET STE 1000 BALTIMORE, MD 21230 PHONE: XXX-XXX-XXXX

ENGINEER CITYSCAPE ENGINEERING, LLC 3000 CHESTNUT AVE, SUITE 112 BALTIMORE, MD 21211 PHONE: (410) 601-3290

OWNER OWNER ADDRESS PHONE: MAYOR AND CITY COUNCIL

BALTIMORE, MD 21202

DIRECTOR, DEPARTMENT OF TRANSPORTATION CITY OF BALTIMORE DEPARTMENT OF PUBLIC WORKS CHIEF, OFFICE OF ENGINEERING AND CONSTRUCTION 100 N HOLLIDAY STREET

DIRECTOR, DEPARTMENT OF PUBLIC WORKS

CITY OF BALTIMORE DEPARTMENT OF TRANSPORTATION

CHIEF, TRANSPORTATION ENGINEERING & CONSTRUCTION DIVISION

CITY OF BALTIMORE **CONWAY STREET PARK** RIGHT-OF-WAY HARDSCAPE IMPROVEMENTS L301R PLANTING PLAN PROPERTY ADDRESS: 610 W CONWAY STREET BALTIMORE, MD 21230

PLANTING LEGEND

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PLANTING AREA (40% SHRUBS,


60% PERENNIALS + GRASSES)

PROPOSED SHADE TREE


PROPOSED ORNAMENTAL TREE

EXISTING SHADE TREE TO BE PRESERVED


SCALE: AS SHOWN SHEET: OF XX

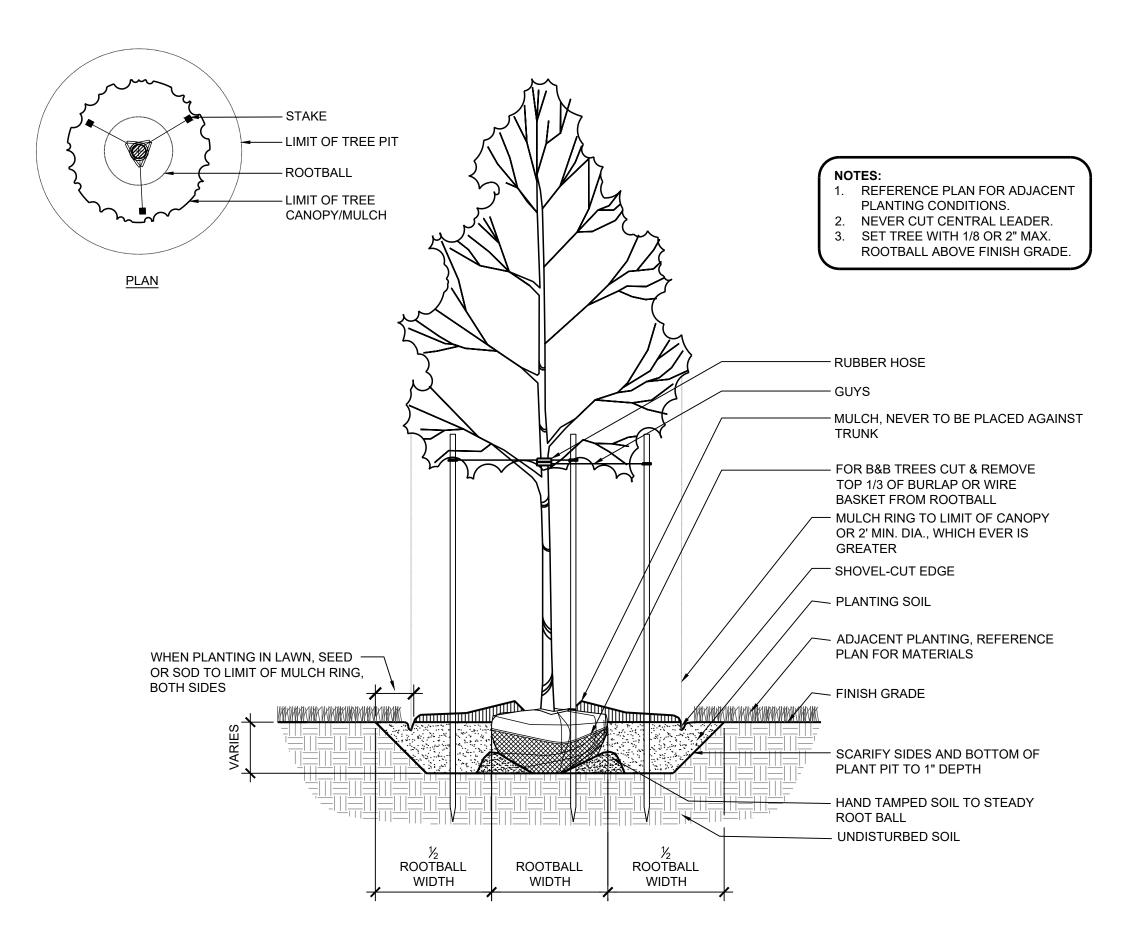


SINGLE STEM SHADE TREE PLANTING

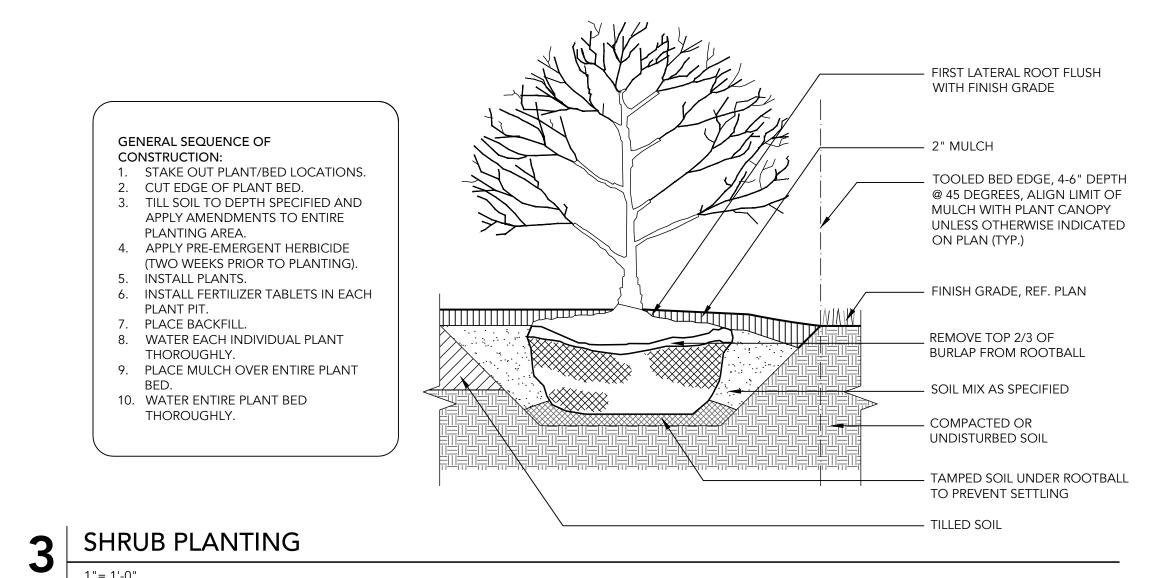

WARD: 22 DESIGNED: JS, HT
DRAWN: JS, CO
CHECKED: HT, CO SECTION: 060 SECT. APP. BLOCK: 0861 LOT: 005 EROSION AND WASTE WATER R/W RELEASE LIGHTING STRUCTURAL CONDUIT SEDIMENT CONTROL ENGINEERING ENGINEERING ESTABLISHED COMPLIANCE WATER DRAINAGE CITY REVIEW ENGINEERING ENGINEERING ENGINEERING DATE

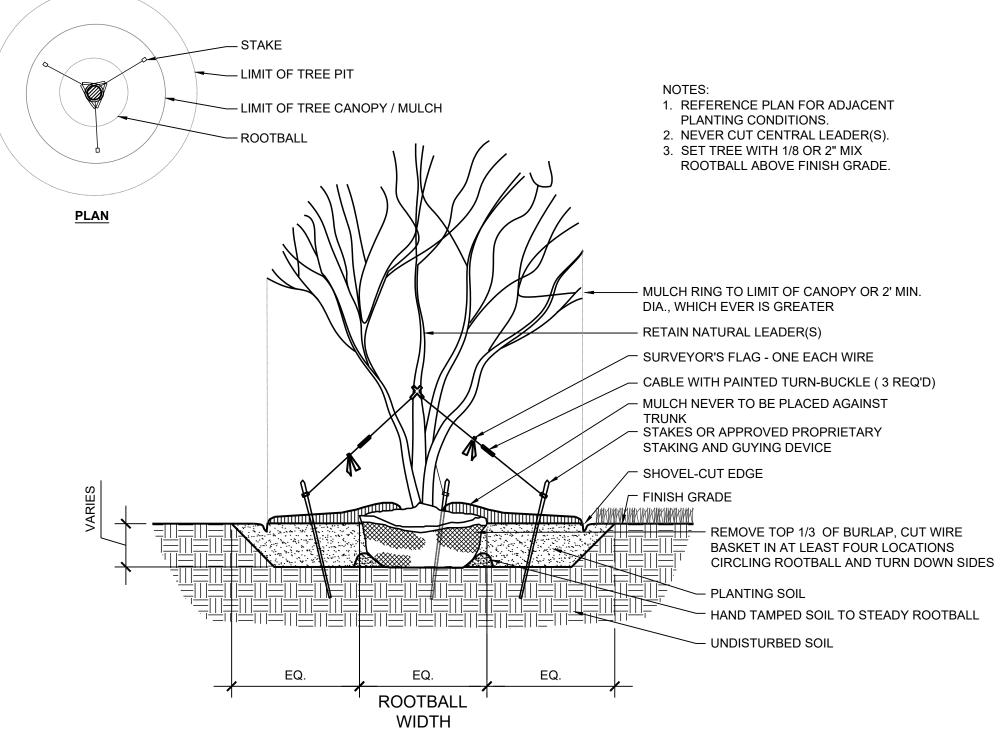

ORNAMENTAL TREE PLANTING

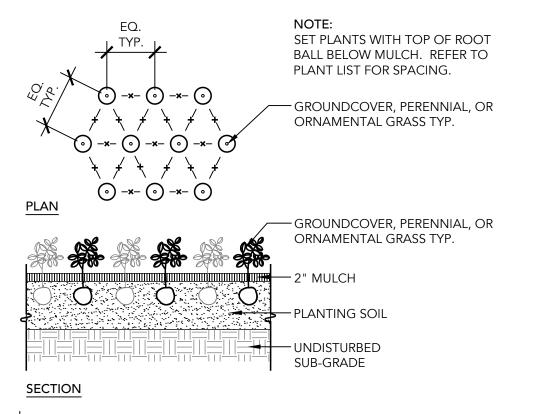

GROUNDCOVER PLANTING

CHIEF, TRANSPORTATION ENGINEERING & CONSTRUCTION DIVISION DIRECTOR, DEPARTMENT OF TRANSPORTATION APPLICANT/DEVELOPER **ENGINEER** OWNER CITY OF BALTIMORE DEPARTMENT OF PUBLIC WORKS APPROVAL RECOMMENDED CITYSCAPE ENGINEERING, LLC APPLICANT/DEVELOPER 3000 CHESTNUT AVE, ADDRESS: SUITE 112 SOUTH BALTIMORE OWNER DATE CHIEF, OFFICE OF ENGINEERING AND CONSTRUCTION GATEWAY PARTNERSHIP BALTIMORE, MD 21211 OWNER ADDRESS PHONE: (410) 601-3290 101 W. DICKMAN STREET PHONE: STE 1000 MAYOR AND CITY COUNCIL BALTIMORE, MD 21230 100 N HOLLIDAY STREET PHONE: XXX-XXX-XXXX

CONWAY STREET PARK RIGHT-OF-WAY HARDSCAPE IMPROVEMENTS L401R PLANTING DETAILS PROPERTY ADDRESS: 610 W CONWAY STREET BALTIMORE, MD 21230 SCALE: AS SHOWN DATE: OF XX SHEET:

CITY OF BALTIMORE

FOR INFORMATION ONLY. NOT FOR CONSTRUCTION.

SCALE: 1"= 1'-0"

BALTIMORE, MD 21202

DIRECTOR, DEPARTMENT OF PUBLIC WORKS

CITY OF BALTIMORE DEPARTMENT OF TRANSPORTATION

SOIL PREPARATION NOTES.

THESE NOTES SERVE AS A GENERAL GUIDE ONLY, PER CSI SPECIFICATION SECTION 329113 (SOIL PREPARATION); REFER TO EROSION AND SEDIMENT CONTROL NOTES, SHEET C-303 FOR DETAILED INSTRUCTIONS ON SITE CLEARING, EROSION CONTROL, SOIL STORAGE, TESTING, PRODUCTS AND EXECUTION PROCEDURES.

- 1. THE CONTRACTOR SHALL ENGAGE A QUALIFIED TESTING AGENCY TO PERFORM PRECONSTRUCTION SOIL ANALYSIS ON EXISTING, ON-SITE SOIL AND IMPORTED SOIL. SOIL ANALYSIS/REPORT TO PROVIDE RECOMMENDATIONS ON: SOIL AMENDMENT, INCLUDING RECOMMENDATIONS FOR NITROGEN, PHOSPHORUS, AND POTASSIUM FERTILIZATION, AND FOR MICRONUTRIENTS; FERTILIZERS; SOIL-FERTILITY ANALYSIS ACCORDING TO SSSA NAPT SERA-6; AND ORGANIC MATTER CONTENT ACCORDING TO SSSA'S METHOD OF SOIL ANALYSIS PART 3 CHEMICAL METHODS. RECOMMENDATIONS TO BE PROVIDED IN WEIGHT PER 1000 SF FOR 6 INCH DEPTH OF SOIL.
- 2. SOIL MATERIALS TO BE DELIVERED PACKAGED IN ORIGINAL, UNOPENED CONTAINERS SHOWING WEIGHT, CERTIFIED ANALYSIS, NAME AND ADDRESS OF MANUFACTURER, AND COMPLIANCE WITH STATE AND FEDERAL LAWS IF APPLICABLE; APPROPRIATE CERTIFICATES TO ACCOMPANY DELIVERY OF BULK FERTILIZERS AND AMENDMENTS.
- 3. DO NOT DUMP/STORE BULK MATERIALS NEAR STRUCTURES, UTILITIES, PAVEMENT, OR EXISTING TURF OR PLANT AREAS; PROVIDE EROSION CONTROL MEASURES AS NEEDED.
- 4. BASED ON SOIL AGENCY RECOMMENDATION, PROVIDE EITHER AMENDED ON-SITE SURFACE SOIL, OR IMPORTED MANUFACTURER SOIL CONSISTING OF MANUFACTURER'S BASIC SANDY LOAM ACCORDING TO USDA TEXTURES, BLENDED IN A FACILITY WITH SAND, STABILIZED ORGANIC SOIL AMENDMENTS, AND OTHER MATERIALS TO PRODUCE VIABLE PLANTING SOIL. SOIL MUST NOT CONTAIN ANY EXTRANEOUS MATERIALS THAT COULD BE HARMFUL TO PLANT GROWTH, NOR ANY STONES,
- ROOTS, POCKETS OF COURSE SAND, ETC., EXCEEDING 1 ½ INCHES IN ANY DIMENSION.
- BLEND EITHER AMENDED ONSITE SOIL OR IMPORTED SOIL WITH LOOSE COMPACT TO SOIL RATIO OF 1:4 BY VOLUME. 6. APPLY INORGANIC AND ORGANIC SOIL AMENDMENTS AND FERTILIZERS PER RECOMMENDATION OF QUALIFIED SOIL TESTING
- 7. FOR EITHER PLACING AND MIXING PLANTING SOIL OVER EXPOSED SUBGRADE, OR PLACING MANUFACTURED PLANTING SOIL OVER EXPOSED SUBGRADE: TILL SUBGRADE TO A MINIMUM DEPTH OF 8 INCHES; APPLY HALF OF THICKNESS OF PLANTING SOIL OVER PREPARED, LOOSENED SUBGRADE, MIXING INTO TOP 4 INCHES OF SUBGRADE; SPREAD REMAINDER OF PLANTING SOIL TO TOTAL DEPTH INDICATED ON DRAWINGS, BUT NOT LESS THAN REQUIRED TO MEET FINISH GRADES AFTER NATURAL SETTLEMENT; COMPACT EACH LIFT OF PLANTING SOIL TO 75 TO 82 PERCENT OF MAXIMUM STANDARD PROCTOR DENSITY ACCORDING TO ASTM D698 EXCEPT WHERE DIFFERENT COMPACTON IS INDICATED ON DRAWINGS; GRADE PLANTING SOIL TO A SMOOTH, UNIFORM SURFACE PLANE WITH LOOSE, UNIFORMLY FINE TEXTURE; AND ROLL AND RAKE TO REMOVE RIDGES AND FILL DEPRESSIONS TO MEET FINISH GRADES.
- 8. IDENTIFY PROTECTION ZONES ACCORDING TO SECTION 015639 (TEMPORARY TREE AND PLANT PROTECTION), AND PROHIBIT PRACTICES IN THESE AREAS SUCH AS STORAGE OF MATERIALS, PARKING VEHICLES OR EQUIPMENT, VEHICLE OR FOOT TRAFFIC, ERECTION OF STRUCTURES, IMPOUNDMENT OF WATER, AND EXCAVATION.
- 9. IF PLANTING SOIL OR SUBGRADE IS OVERCOMPACTED, DISTURBED, OR CONTAMINATED BY FOREIGN OR DELETERIOUS MATERIALS OR LIQUIDS, REMOVE THE PLANTING SOIL AND CONTAMINATION AND RESTORE SUBGRADE AND REPLACE CONTAMINATED PLANTING SOIL WITH NEW PLANTING SOIL.
- 10. PROTECT AREAS ADJACENT TO PLANTING SOIL PREPARATION AND PLACEMENT AREAS FROM CONTAMINATION. KEEP ADJACENT PAVING AND CONSTRUCTION CLEAN AND WORK AREA IN AN ORDERLY CONDITION.
- 11. REMOVE SURPLUS SOIL AND WASTE MATERIAL INCLUDING EXCESS SUBSOIL, UNSUITABLE MATERIALS, TRASH, AND DEBRIS AND LEGALLY DISPOSE OF THEM OFF OWNER'S PROPERTY UNLESS OTHERWISE INDICATED.

PLANTING NOTES.

R/W RELEASE

CITY REVIEW

DATE

LIGHTING

ENGINEERING ENGINEERING

- 1. THE CONTRACTOR SHALL PROVIDE ALL MATERIALS, LABOR AND EQUIPMENT TO COMPLETE ALL LANDSCAPE WORK AS SHOWN ON THE PLANS AND SPECIFICATIONS.
- 2. ALL PLANT MATERIALS SHALL CONFORM TO THE SIZES GIVEN IN THE PLANT LIST AND SHALL BE NURSERY GROWN IN ACCORDANCE WITH THE "AMERICAN STANDARD FOR NURSERY STOCK," LATEST EDITION. ANY PLANT MATERIAL EXHIBITING A
- SPINDLY OR LOP-SIDED HABIT OR ANY OTHER FEATURE THAT DETRACTS FROM ITS HEALTH OR APPEARANCE WILL BE REJECTED. 3. ALL PLANTING SHALL BE IN ACCORDANCE WITH STANDARD AMERICAN ASSOCIATION OF NURSERYMEN PROCEDURES AND
- 4. CONTRACTOR SHALL VERIFY THE CORRECT LOCATION OF ALL UNDERGROUND UTILITIES WITHIN THE LANDSCAPED AREA PRIOR TO INSTALLATION OF ANY PLANT MATERIAL. IF CONDITIONS ARISE IN THE FIELD WHICH NECESSITATES SHIFTING OF THE PLANT MATERIAL, THE LANDSCAPE ARCHITECT IS TO BE CONSULTED PRIOR TO RELOCATION.
- OBTAIN WRITTEN APPROVAL FROM LANDSCAPE ARCHITECT BEFORE MAKING ANY SUBSTITUTIONS OR CHANGES.
- 6. PRECAUTIONS SHALL BE TAKEN TO AVOID DAMAGE TO EXISTING PLANTS, TURF AND STRUCTURES. ANY DAMAGED AREAS SHALL BE RESTORED TO THEIR ORIGINAL CONDITIONS. ALL AREAS DISTURBED BY PLANTING OR GRADING OPERATIONS SHALL BE FINE GRADED AND SEEDED OR SODDED. ALL DEBRIS AND WASTE MATERIAL RESULTING FROM PLANTING OPERATIONS SHALL BE REMOVED FROM THE PROJECT AND CLEANED UP.

DESIGNED: JS, HT

CHECKED: HT, CO

DRAWN:

STRUCTURAL CONDUIT

- 7. PLACE PLANTS FOR BEST APPEARANCE FOR REVIEW AND FINAL ORIENTATION BY LANDSCAPE ARCHITECT.
- 8. ALL PLANT BEDS SHALL BE CONTAINED WITH A 4" DEEP SPACED EDGE UNLESS OTHERWISE NOTED ON DRAWINGS. 9. ALL PLANT BEDS AND PLANTING AREAS TO BE MULCHED TO A DEPTH OF 2" UNLESS OTHERWISE NOTED ON DRAWINGS OR SPECIFICATIONS.

MAINTENANCE.

REQUIRED LANDSCAPING MUST BE KEPT ALIVE AND HEALTHY TO CONTINUE TO MEET THE REQUIREMENTS OF THE BALTIMORE CITY LANDSCAPE MANUAL AND THE ZONING CODE. PROPER MAINTENANCE AND IRRIGATION MUST BE PROVIDED FOR ALL INSTALLED LANDSCAPING.

THE MAINTENANCE OF PLANTS INSTALLED IS REQUIRED FOR SUCCESSFUL LANDSCAPING. PLANTS CANNOT BE INSTALLED AND LEFT ALONE, ESPECIALLY IN URBAN ENVIRONMENTS WHERE THEY MAY BE SUBJECT TO HIGH TEMPERATURES, HARSH ENVIRONMENTS, AND PHYSICAL ABUSE. GIVEN THE STRESSES AND RIGORS TO WHICH PLANTS ARE SUBJECTED, PLANTS MAY REQUIRE REPLACEMENT. A TWO-YEAR REPLACEMENT WARRANTY IS REQUIRED FOR ALL PLANTS AND A MAINTENANCE CONTRACT IS ENCOURAGED TO PROMOTE THE ESTABLISHMENT OF PLANTS AND ENCOURAGE PROPER LANDSCAPE MAINTENANCE. BEYOND THE WARRANTY PERIOD, THE CONTINUED MAINTENANCE OF THE LANDSCAPE IS THE RESPONSIBILITY OF THE PROPERTY OWNER FOR THE LIFE OF THE PROJECT.

REQUIREMENTS FOR LANDSCAPE MAINTENANCE ARE AS FOLLOWS:

- MAINTENANCE OF LANDSCAPED AREAS INCLUDES, BUT IS NOT LIMITED TO WEEDING, MULCHING, MOWING, TRIMMING, PRUNING, EDGING, CULTIVATION, SEEDING, FERTILIZATION, WATERING, PEST CONTROL, AND ANY OTHER
- MAINTENANCE NECESSARY TO ENSURE HEALTHY, VIGOROUS PLANT GROWTH AND WELL-KEPT PROPERTY CONDITION. LANDSCAPING ELEMENTS SUCH AS WALLS AND FENCES SHALL BE CONSTRUCTED IN A SOUND WORKMANLIKE MANNER WITH ADEQUATE SUPPORT OR FOOTINGS AND MUST BE REPAIRED OR REPLACED AS NEEDED TO PRESERVE AN ATTRACTIVE APPEARANCE AND TO FUNCTION AS INTENDED.
- ANY DEAD PLANTS OR PLANTS WHICH FAIL TO SHOW HEALTHY GROWTH MUST BE REMOVED AND REPLACED WITHIN 60 DAYS OF IDENTIFICATION OF DETERIORATED HEALTH OR NOTIFICATION BY THE CITY. REPLACEMENT MAY BE DELAYED UNTIL THE NEXT GROWING SEASON ONLY IF THE 60 DAY PERIOD OCCURS DURING A TIME OF YEAR NOT SUITABLE FOR
- ALL REPLACEMENT PLANTS MUST MEET THE SIZE AND OTHER CHARACTERISTICS OF NEWLY PLANTED MATERIAL AS REQUIRED IN THE MANUAL.
- TREES AND LARGE SHRUBS MUST BE ADEQUATELY SUPPORTED, WHEN NECESSARY TO INSURE PROPER GROWTH. TREE STAKING MUST BE REMOVED PRIOR TO FINAL INSPECTION, WITH THE EXCEPTION OF PLANTS REPLACED DURING THE WARRANTY PERIOD AND NOT YET ESTABLISHED.
- IT IS DESIRABLE TO AVOID EXCESSIVE USE OF FERTILIZERS, HERBICIDES, AND PESTICIDES TO MINIMIZE IMPACTS ON WATER QUALITY. IT IS RECOMMENDED THAT FERTILIZER APPLICATION BE NEED-BASED RATHER THAN AS AN AUTOMATIC COMPONENT OF MAINTENANCE SCHEDULES AND WHEN APPROPRIATE, SLOW-RELEASE OR NATURAL FERTILIZERS BE SELECTED OVER HIGHLY-SOLUBLE CHEMICAL FERTILIZERS.
- APPLICATION OF HERBICIDES AND PESTICIDES SHALL BE PERFORMED BY A CERTIFIED PROFESSIONAL ONLY.
- THE IMPLEMENTATION OF AN INTEGRATED PEST MANAGEMENT (IPM) PROGRAM IS RECOMMENDED TO PREVENT AND TREAT PEST PROBLEMS.

IRRIGATION.

WARD: 22

SECTION: 060

BLOCK: 0861

WATER

ENGINEERING ESTABLISHED COMPLIANCE

LOT: 005

EROSION AND

WATER

CONTROL ENGINEERING

SEDIMENT

DRAINAGE

ENGINEERING

SECT. APP.

ALL PLANTS NEED SUPPLEMENTAL WATER DURING THE FIRST AND SECOND GROWING SEASONS TO ESTABLISH THEIR ROOT SYSTEMS; HOWEVER, A PERMANENT IRRIGATION SYSTEM IS NOT REQUIRED. A GENERAL GUIDELINE FOR ESTABLISHMENT IS TO PROVIDE IRRIGATION AT A RATE OF ONE INCH OF WATER PER WEEK, INCLUDING THAT THROUGH RAINFALL. RECOMMENDED TECHNIQUES TO REDUCE WATER REQUIREMENTS AND APPROVED METHODS FOR THE PROVISION OF WATER SUPPLY TO PLANTS INCLUDE THE FOLLOWING:

IRRIGATION METHODS.

- 1. THE USE AND MAINTENANCE OF DRIP IRRIGATION BAGS OR RINGS AROUND THE TRUNKS OF NEWLY-PLANTED TREES. 2. HAND WATERING, WITH WATER SOURCES PROVIDED THROUGH EITHER OR BOTH OF THE FOLLOWING METHODS:
 - EXTERIOR FAUCETS ON A BUILDING, LOCATED SO THAT THE FARTHEST PLANTING CAN BE REACHED BY A LENGTH
 - OF HOSE (100 FEET RECOMMENDED). A QUICK-COUPLING SYSTEM, WITH CONNECTIONS LOCATED SO THAT THE FARTHEST PLANTING CAN BE
 - REACHED BY A LENGTH OF HOSE (100 FEET RECOMMENDED). A WATER TANK OR TRUCK.
- 3. AN AUTOMATIC IRRIGATION SYSTEM WITH A MOISTURE-SENSING DEVICE AND/OR RAIN SHUT-OFF SWITCH. IF USING AN AUTOMATIC IRRIGATION SYSTEM, THE FOLLOWING REQUIREMENTS SHALL BE MET:
 - ALL IRRIGATION SYSTEMS SHALL BE DESIGNED TO MINIMIZE VANDALISM.
 - SPRINKLERS MUST NOT OVER-SPRAY ONTO PAVEMENT. SPRINKLER AND SPRAY HEADS ARE NOT PERMITTED FOR PLANTING AREAS LESS THAN 8 FEET IN WIDTH, TO PREVENT OVERSPRAY AND RUN-OFF. OTHER IRRIGATION METHODS SHALL BE SPECIFIED IN SUCH AREAS.
 - PLACE LAWN AREAS IN A SEPARATE IRRIGATION ZONE FROM SHRUB AND GROUNDCOVER BEDS, SO THAT EACH PLANTING TYPE CAN RECEIVE ADEQUATE IRRIGATION WITHOUT OVER-WATERING AREAS WITH LOWER IRRIGATION NEEDS.
 - DRIP IRRIGATION IS RECOMMENDED FOR SHRUB AND GROUNDCOVER BEDS. DRIP IRRIGATION SHALL BE USED IN AREAS SMALLER THAN FIVE FEET IN ANY DIRECTION.
- 4. THE USE OF RAINWATER HARVESTING TECHNIQUES COMBINED WITH THE USE OF HARVESTED RAINWATER FOR LANDSCAPE IRRIGATION IS ENCOURAGED.

CHIEF. TRANSPORTATION ENGINEERING & CONSTRUCTION DIVISION DIRECTOR, DEPARTMENT OF TRANSPORTATION **ENGINEER** CITY OF BALTIMORE DEPARTMENT OF PUBLIC WORKS APPLICANT/DEVELOPER OWNER APPROVAL RECOMMENDED CITYSCAPE ENGINEERING, LLC APPLICANT/DEVELOPER 3000 CHESTNUT AVE, ADDRESS: SOUTH BALTIMORE SUITE 112 **OWNER** CHIEF, OFFICE OF ENGINEERING AND CONSTRUCTION GATEWAY PARTNERSHIP BALTIMORE, MD 21211 OWNER ADDRESS PHONE: (410) 601-3290 101 W. DICKMAN STREET PHONE: STE 1000 MAYOR AND CITY COUNCIL BALTIMORE, MD 21230 100 N HOLLIDAY STREET PHONE: XXX-XXX-XXXX BALTIMORE, MD 21202

CITY OF BALTIMORE DEPARTMENT OF TRANSPORTATION

DIRECTOR, DEPARTMENT OF PUBLIC WORKS

CONWAY STREET PARK RIGHT-OF-WAY HARDSCAPE IMPROVEMENTS PLANTING NOTES PROPERTY ADDRESS: 610 W CONWAY STREET BALTIMORE, MD 21230 SCALE: AS SHOWN SHEET: OF XX

CITY OF BALTIMORE

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